

EXHIBIT A


100% FINAL Design Drawings_Civil_Iron Gate (Dec2022) (CEII)

CRITICAL ENERGY/ELECTRIC INFRASTRUCTURE INFORMATION (CEII)

FOLLOWING DRAWINGS REDACTED IN ENTIRETY

C4050, C4051, C4052, C4055, C4100, C4108, C4120, C4121, C4122, C4123, C4124, C4125, C4130, C4131, C4132, C4133, C4170, C4175, C4176, C4190, C4191, C4192, C4193, C4194, C4195, C4196, C4200, C4201, C4203, C4204, C4205, C4206, C4207, C4208, C4209, C4230, C4231, C4235, C4236, 4237, C4238, C4239, C4250, C4255, C4300, C4301, C4405, C4500, C4510, C4515, C4520, C4521, C4600, C4601, C4605, C4615

The redacted material qualifies as CEII pursuant to the Commission's rules because it contains sensitive dam safety and construction information that (a) relates details about the production, generation, transmission, or distribution of energy, (b) could be useful to a person planning an attack on critical infrastructure, (c) is exempt from mandatory disclosure under the Freedom of Information Act, and (d) gives strategic information beyond the location of the critical infrastructure. Accordingly, the Renewal Corporation has requested confidential treatment of this material pursuant to 18 C.F.R. § 388.113.

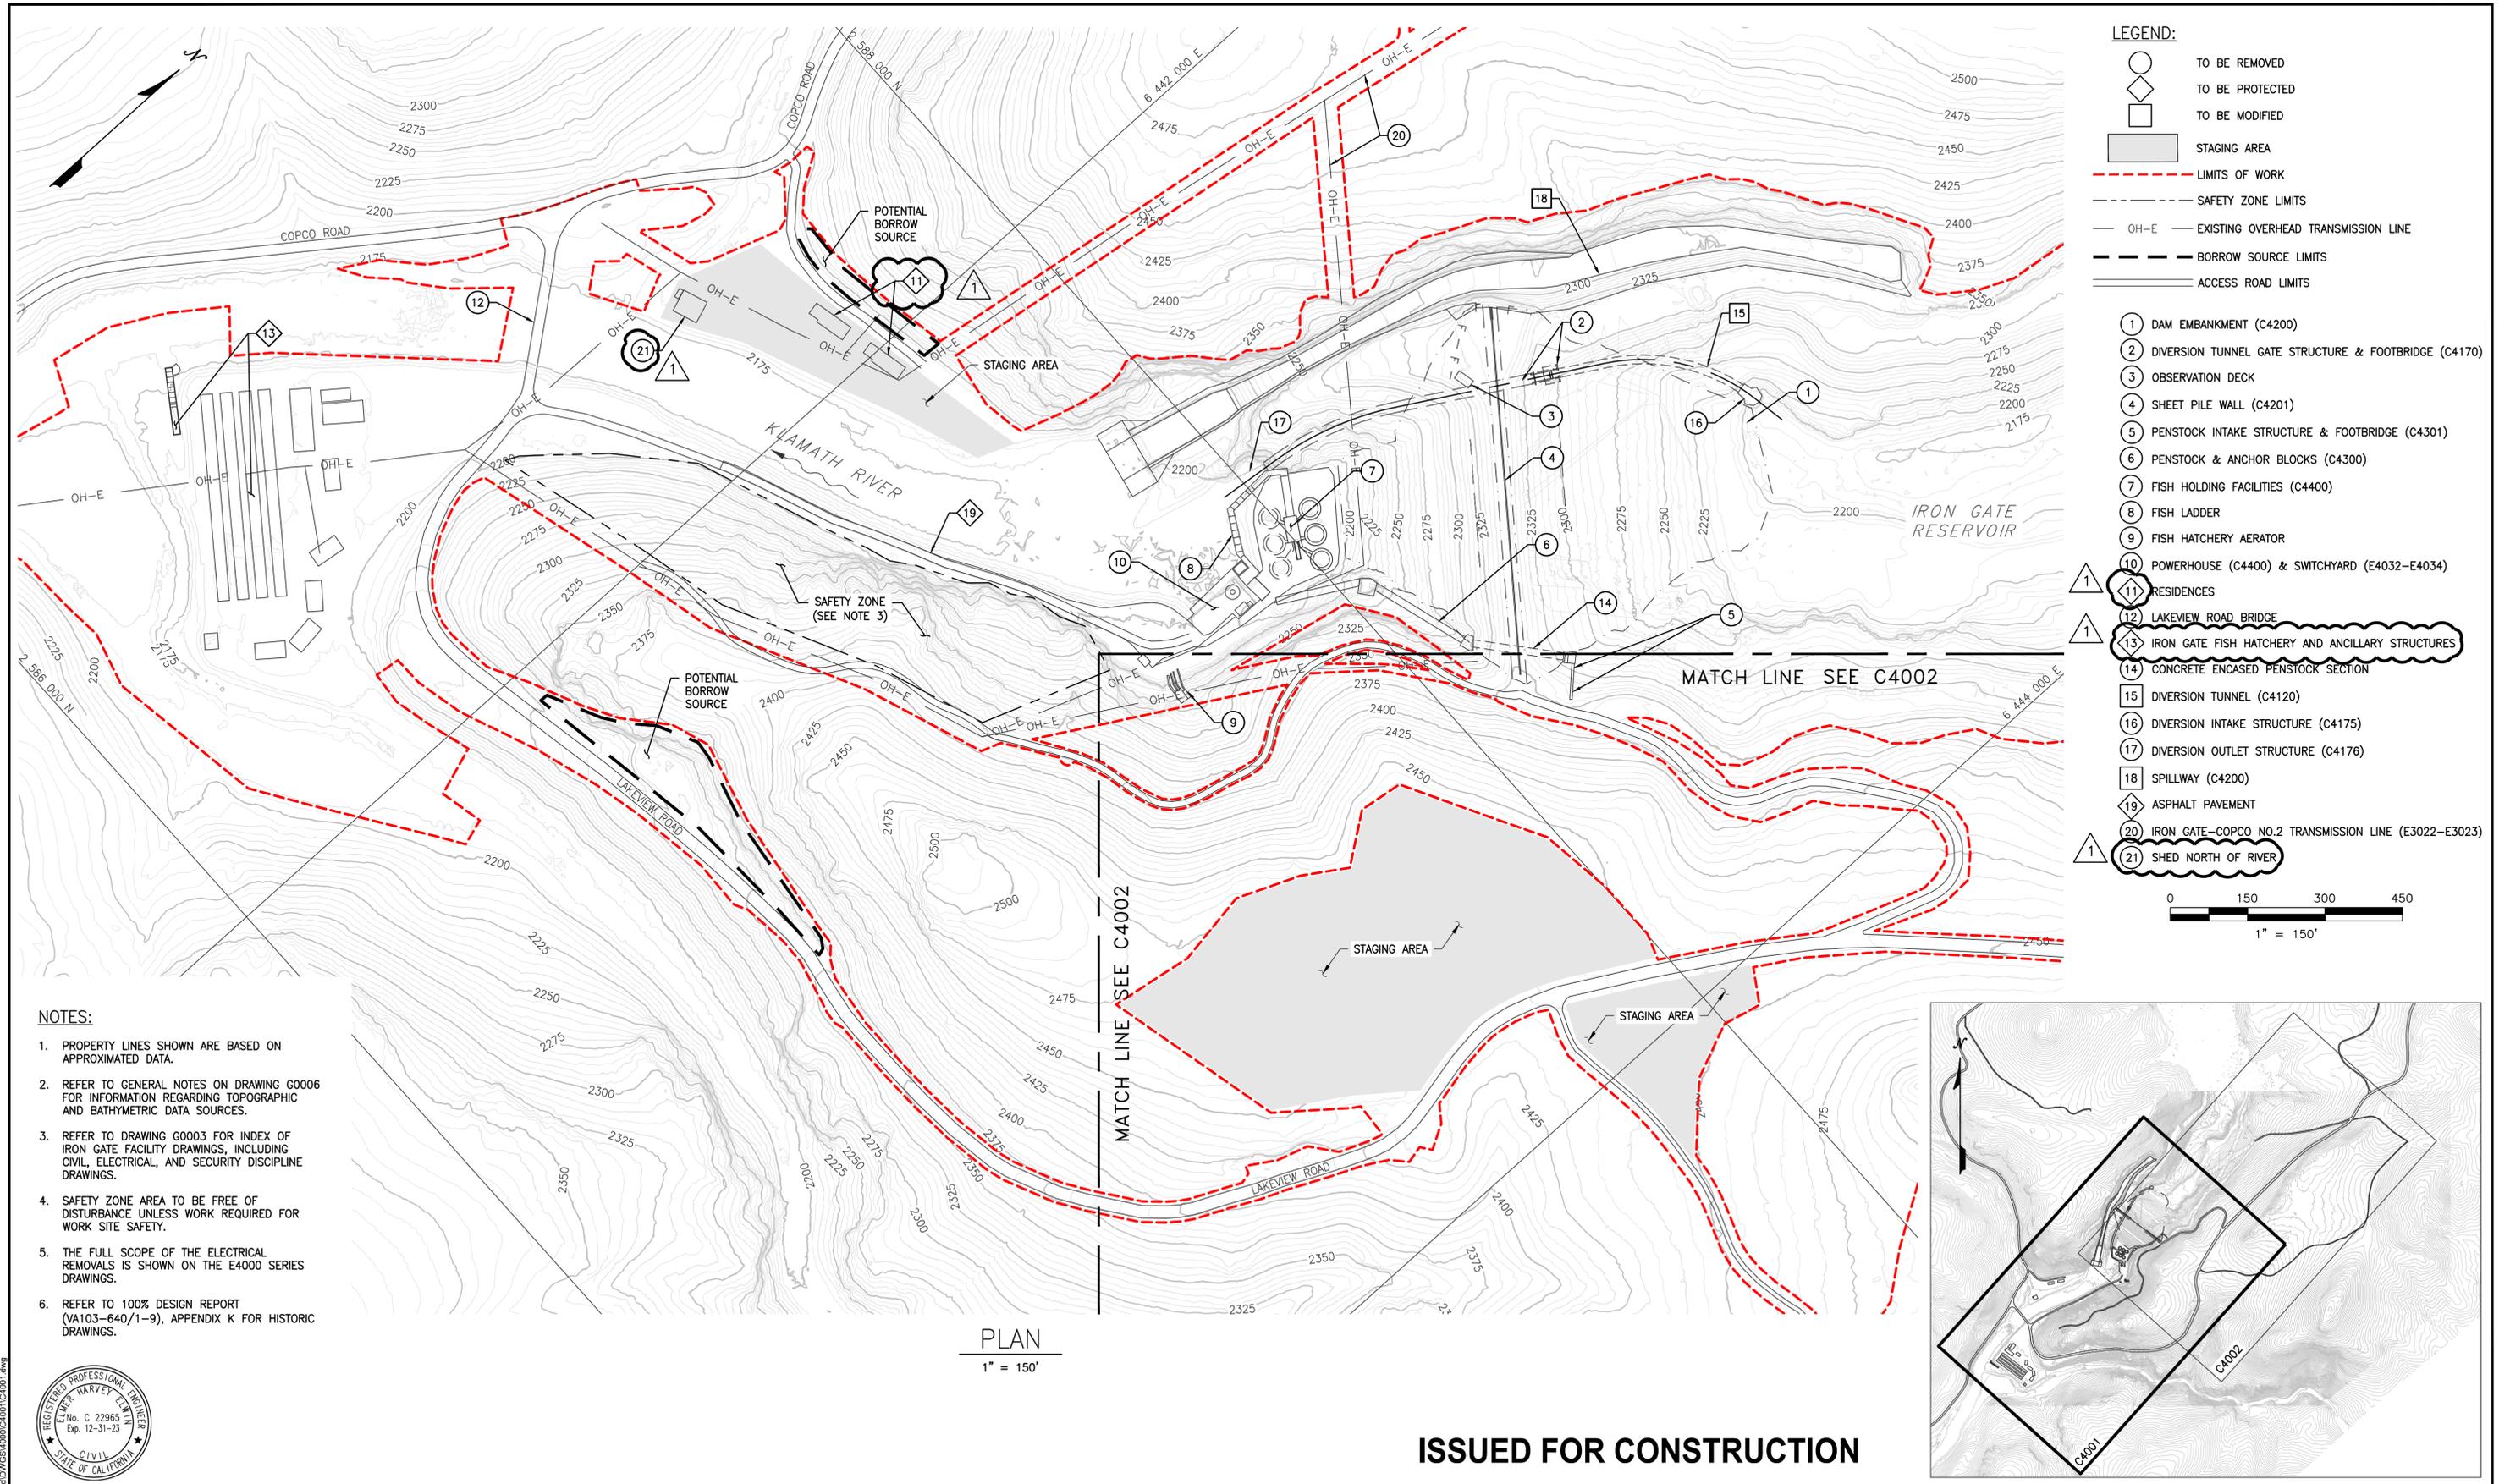

- LEGEND:**
- TO BE REMOVED
 - TO BE PROTECTED
 - TO BE MODIFIED
 - STAGING AREA
 - LIMITS OF WORK
 - SAFETY ZONE LIMITS
 - OH-E EXISTING OVERHEAD TRANSMISSION LINE
 - BORROW SOURCE LIMITS
 - ACCESS ROAD LIMITS
- 1 DAM EMBANKMENT (C4200)
 - 2 DIVERSION TUNNEL GATE STRUCTURE & FOOTBRIDGE (C4170)
 - 3 OBSERVATION DECK
 - 4 SHEET PILE WALL (C4201)
 - 5 PENSTOCK INTAKE STRUCTURE & FOOTBRIDGE (C4301)
 - 6 PENSTOCK & ANCHOR BLOCKS (C4300)
 - 7 FISH HOLDING FACILITIES (C4400)
 - 8 FISH LADDER
 - 9 FISH HATCHERY AERATOR
 - 10 POWERHOUSE (C4400) & SWITCHYARD (E4032-E4034)
 - 11 RESIDENCES
 - 12 LAKEVIEW ROAD BRIDGE
 - 13 IRON GATE FISH HATCHERY AND ANCILLARY STRUCTURES
 - 14 CONCRETE ENCASED PENSTOCK SECTION
 - 15 DIVERSION TUNNEL (C4120)
 - 16 DIVERSION INTAKE STRUCTURE (C4175)
 - 17 DIVERSION OUTLET STRUCTURE (C4176)
 - 18 SPILLWAY (C4200)
 - 19 ASPHALT PAVEMENT
 - 20 IRON GATE-COPCO NO.2 TRANSMISSION LINE (E3022-E3023)
 - 21 SHED NORTH OF RIVER


- NOTES:**
1. PROPERTY LINES SHOWN ARE BASED ON APPROXIMATED DATA.
 2. REFER TO GENERAL NOTES ON DRAWING G0006 FOR INFORMATION REGARDING TOPOGRAPHIC AND BATHYMETRIC DATA SOURCES.
 3. REFER TO DRAWING G0003 FOR INDEX OF IRON GATE FACILITY DRAWINGS, INCLUDING CIVIL, ELECTRICAL, AND SECURITY DISCIPLINE DRAWINGS.
 4. SAFETY ZONE AREA TO BE FREE OF DISTURBANCE UNLESS WORK REQUIRED FOR WORK SITE SAFETY.
 5. THE FULL SCOPE OF THE ELECTRICAL REMOVALS IS SHOWN ON THE E4000 SERIES DRAWINGS.
 6. REFER TO 100% DESIGN REPORT (VA103-640/1-9), APPENDIX K FOR HISTORIC DRAWINGS.

PLAN
1" = 150'

ISSUED FOR CONSTRUCTION



REV	DESCRIPTION	BY	CHK	APP	DATE
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0	ISSUED FOR CONSTRUCTION	KTW	HE	SRM	05/27/22

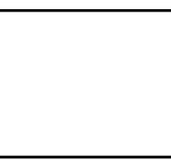


PREPARED BY

DESIGNED	K. WECHSELBERGER
DRAWN	R. McLELLAN
REVIEWED	H. ELWIN
IN CHARGE	N. BISHOP
APPROVED	S. MOTTRAM

PREPARED FOR


PROJECT	KLAMATH RIVER RENEWAL PROJECT
SHEET TITLE	IRON GATE FACILITY PROJECT OVERVIEW AND LIMITS OF WORK (SHEET 1 OF 2)

PROJ#	VA103-640/1
DATE	05/27/2022
DWG	C4001

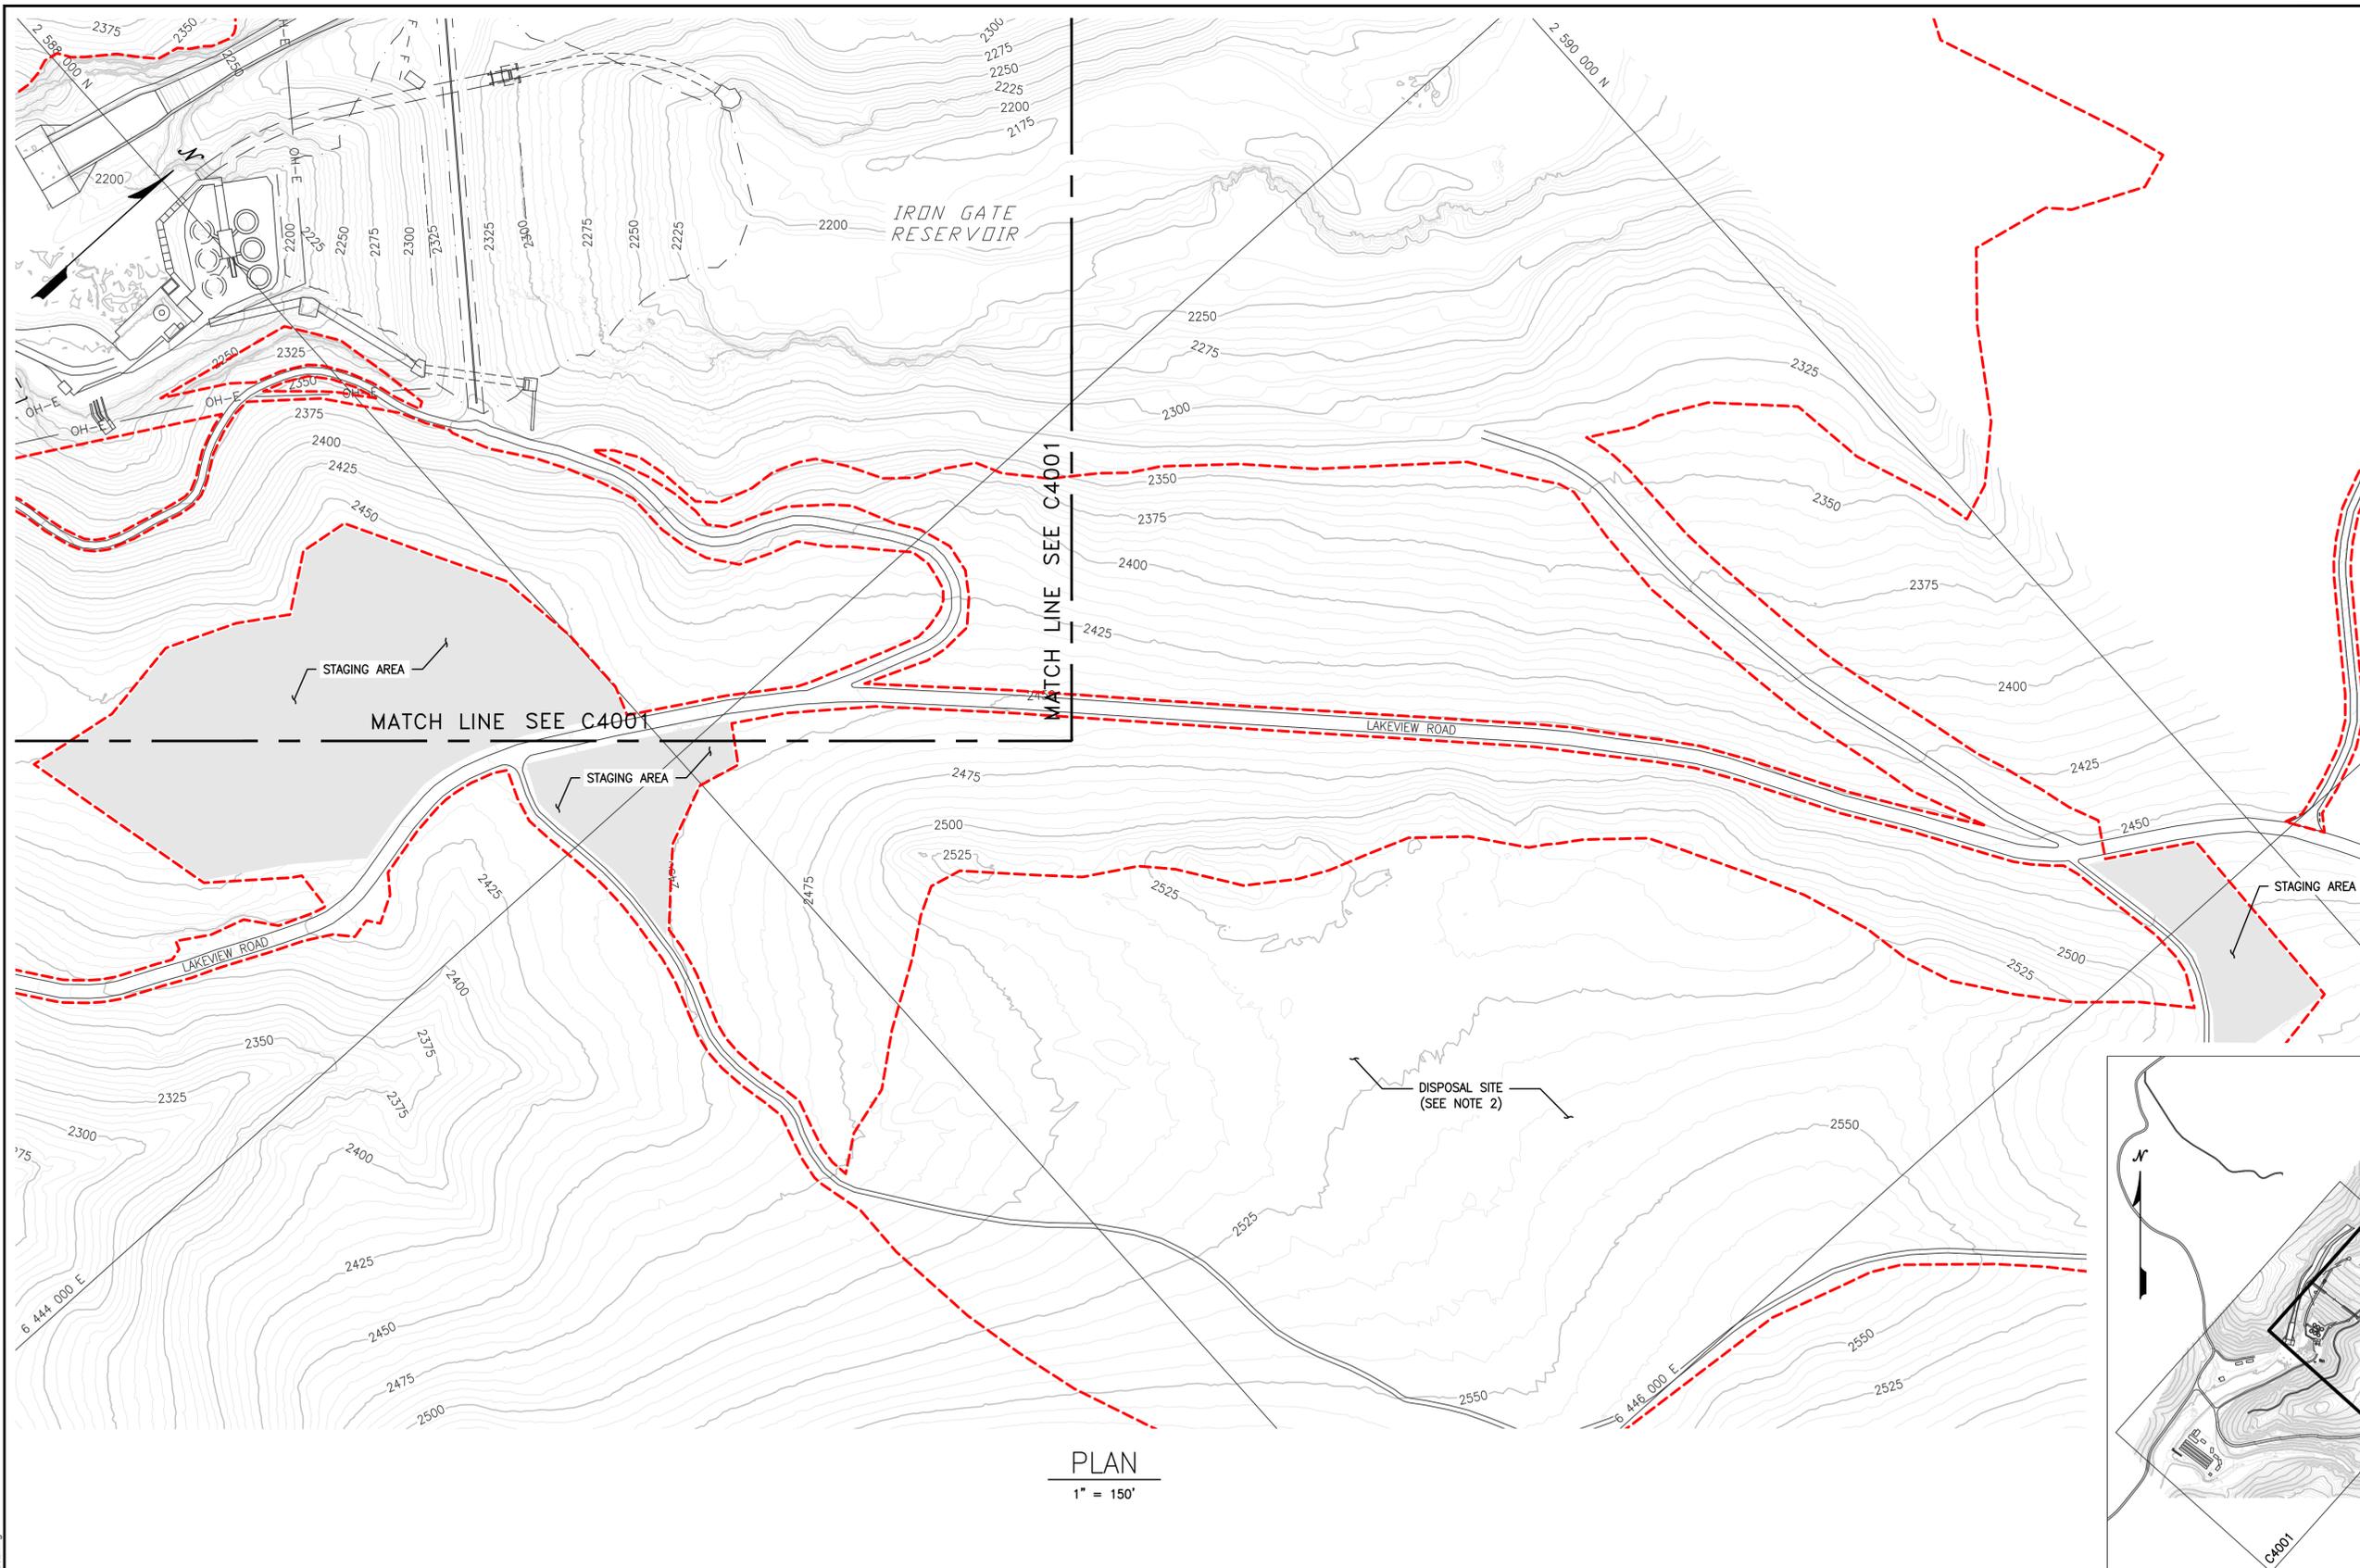

- LEGEND:**
-  STAGING AREA
 -  LIMITS OF WORK
 -  ACCESS ROAD LIMITS

- NOTES:**
1. PROPERTY LINES SHOWN ARE BASED ON APPROXIMATED DATA.
 2. EXACT DISPOSAL SITE BOUNDARY AND CONFIGURATION TO BE ADJUSTED ON SITE BY CONTRACTOR AS NEEDED, BUT SHALL REMAIN INSIDE LIMITS OF WORK.
 3. REFER TO DRAWING G0003 FOR INDEX OF IRON GATE FACILITY DRAWINGS, INCLUDING CIVIL, ELECTRICAL, AND SECURITY DISCIPLINE DRAWINGS.
 4. THE FULL SCOPE OF THE ELECTRICAL REMOVALS IS SHOWN ON THE E4000 SERIES DRAWINGS.
 5. REFER TO 100% DESIGN REPORT (VA103-0640/1-9), APPENDIX K FOR HISTORIC DRAWINGS.

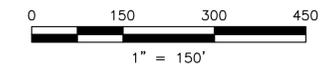

PLAN
1" = 150'



ISSUED FOR CONSTRUCTION

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REV	DESCRIPTION	BY	CHK	APP	DATE
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WARNING
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IF THIS BAR DOES NOT MEASURE 1" THEN DRAWING IS NOT TO SCALE










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REVIEWED	H. ELWIN
IN CHARGE	N. BISHOP
APPROVED	S. MOTTRAM



PROJECT	KLAMATH RIVER RENEWAL PROJECT
SHEET TITLE	IRON GATE FACILITY PROJECT OVERVIEW AND LIMITS OF WORK (SHEET 2 OF 2)

PROJ #	VA103-640/1
DATE	05/27/2022
DWG	C4002

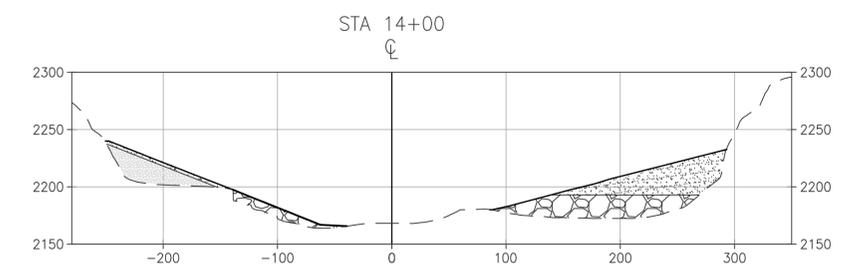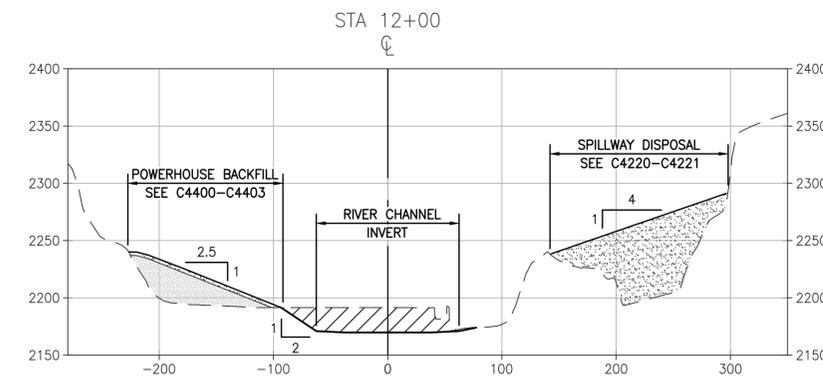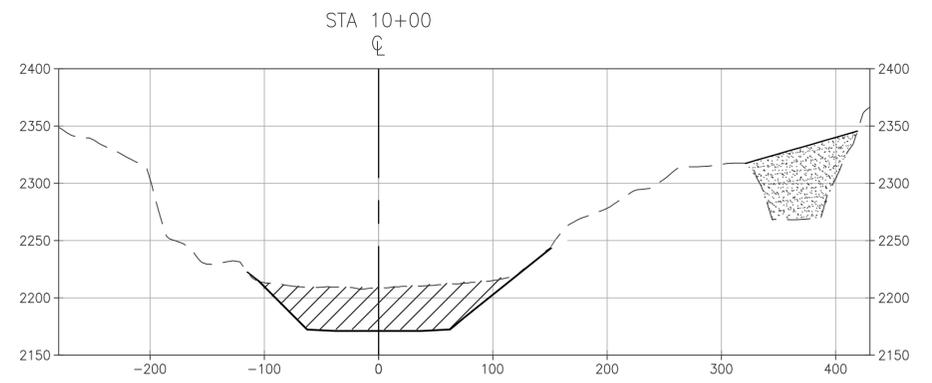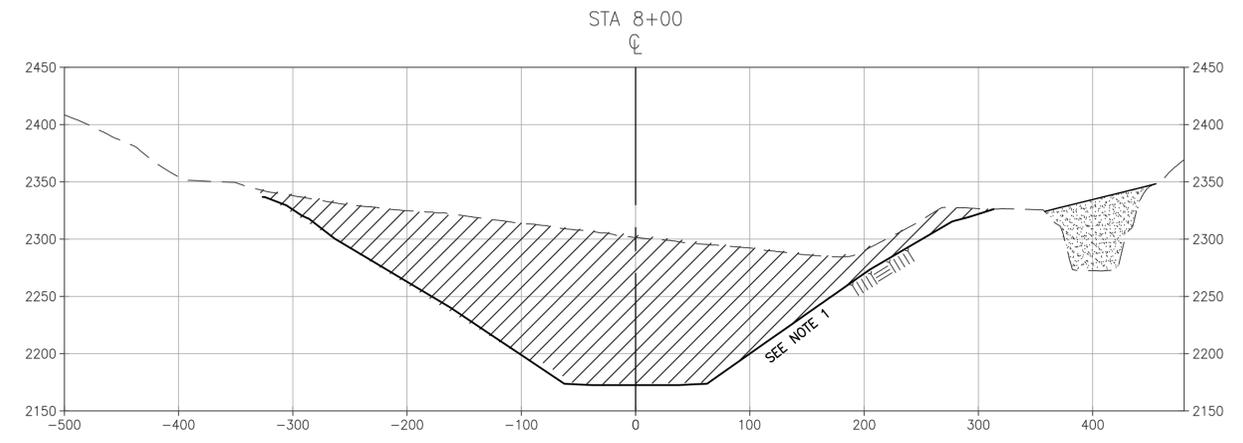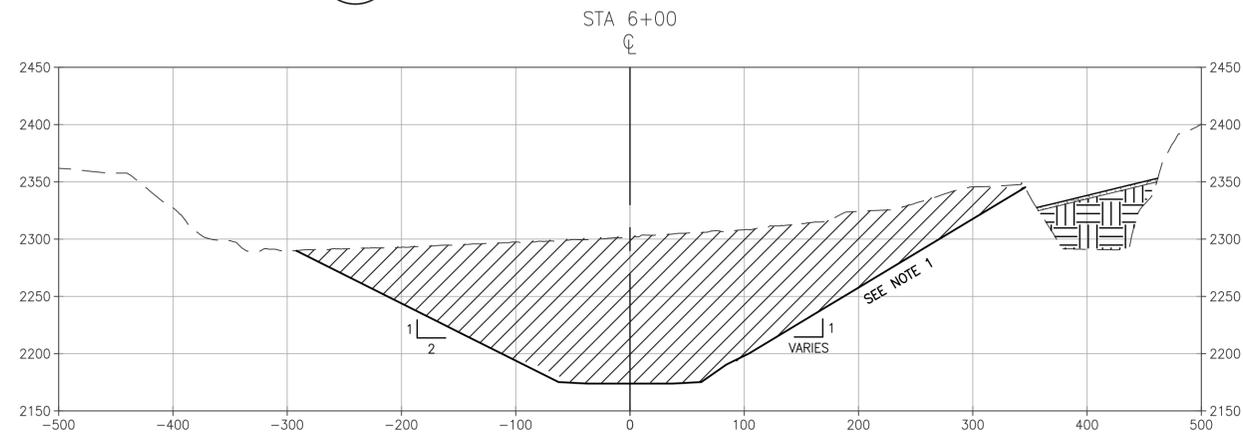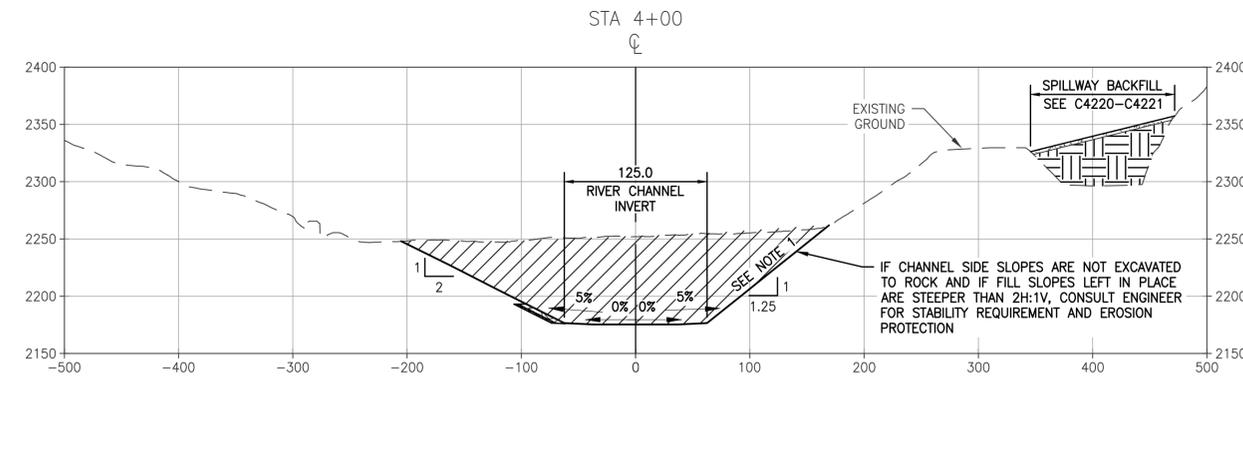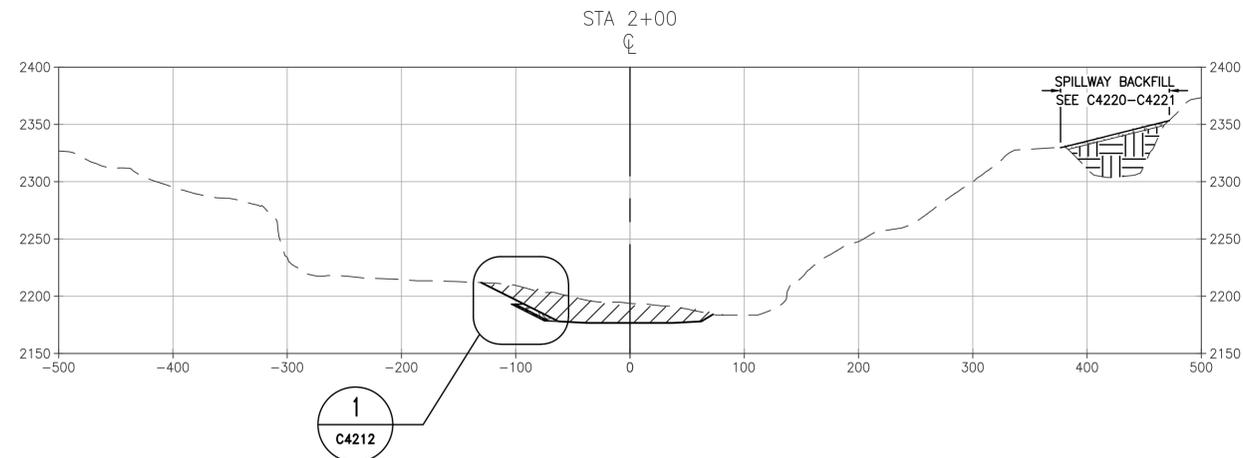


CROSS SECTIONS
1" = 80'

- NOTES:**
- ALL CUT SLOPES STEEPER THAN 2H:1V ARE ASSUMED TO BE IN AN AREA WHERE EXCAVATION WILL BE BEDROCK.
 - ALL CORE ZONE MATERIAL (ZONE III) SHALL BE EXCAVATED TO BEDROCK. ALL OTHER EXCAVATED SURFACE SHALL BE TO BEDROCK OR EXCAVATION EXTENTS SHOWN HERE.
 - ALL FINAL GRADE SURFACES TO BE COVERED AND TREATED ACCORDING TO C4600 DRAWING SERIES.
 - NO EROSION PROTECTION REQUIRED WHERE EXCAVATION IS TO BEDROCK.
 - TOP OF RIPRAP SHALL PROVIDE 3 FT. OF FREEBOARD ON THE 1% PROBABLE WATER SURFACE LEVEL AND SHALL APPROXIMATELY FOLLOW THE CHANNEL SLOPE.

- LEGEND:**
- DIAGONAL HATCHING: DEMOLITION / REMOVAL
 - STIPPLED: GENERAL FILL (E9)
 - CROSS-HATCHING: RANDOM FILL (E10)
 - SOLID GRAY: CONCRETE RUBBLE (CR1/CR2)
 - CIRCULAR PATTERNS: EROSION PROTECTION (E7b)
 - BRICK PATTERNS: BEDDING (E8)


ISSUED FOR CONSTRUCTION

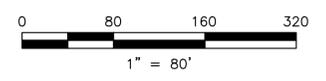

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0	ISSUED FOR CONSTRUCTION	KTW	SY	SRM	05/27/22




WARNING
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IF THIS BAR DOES NOT MEASURE 1" THEN DRAWING IS NOT TO SCALE

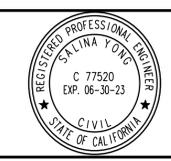

DESIGNED: K. WECHSELBERGER
 DRAWN: A. TSENG
 REVIEWED: S. YONG
 IN CHARGE: N. BISHOP
 APPROVED: S. MOTTRAM



PROJECT	KLAMATH RIVER RENEWAL PROJECT	PROJ#	VA103-640/1
DATE	05/27/2022	DWG	C4211
SHEET TITLE	IRON GATE FACILITY EMBANKMENT REMOVAL GRADING GENERAL ARRANGEMENT SECTIONS		

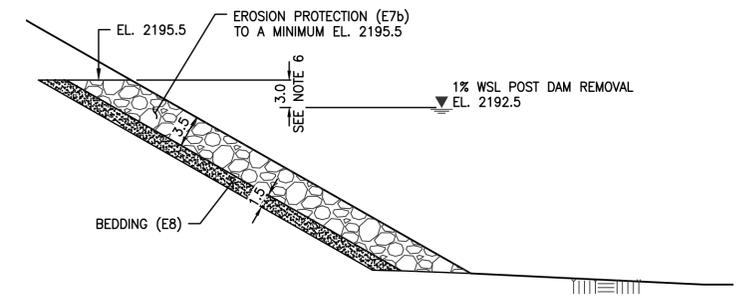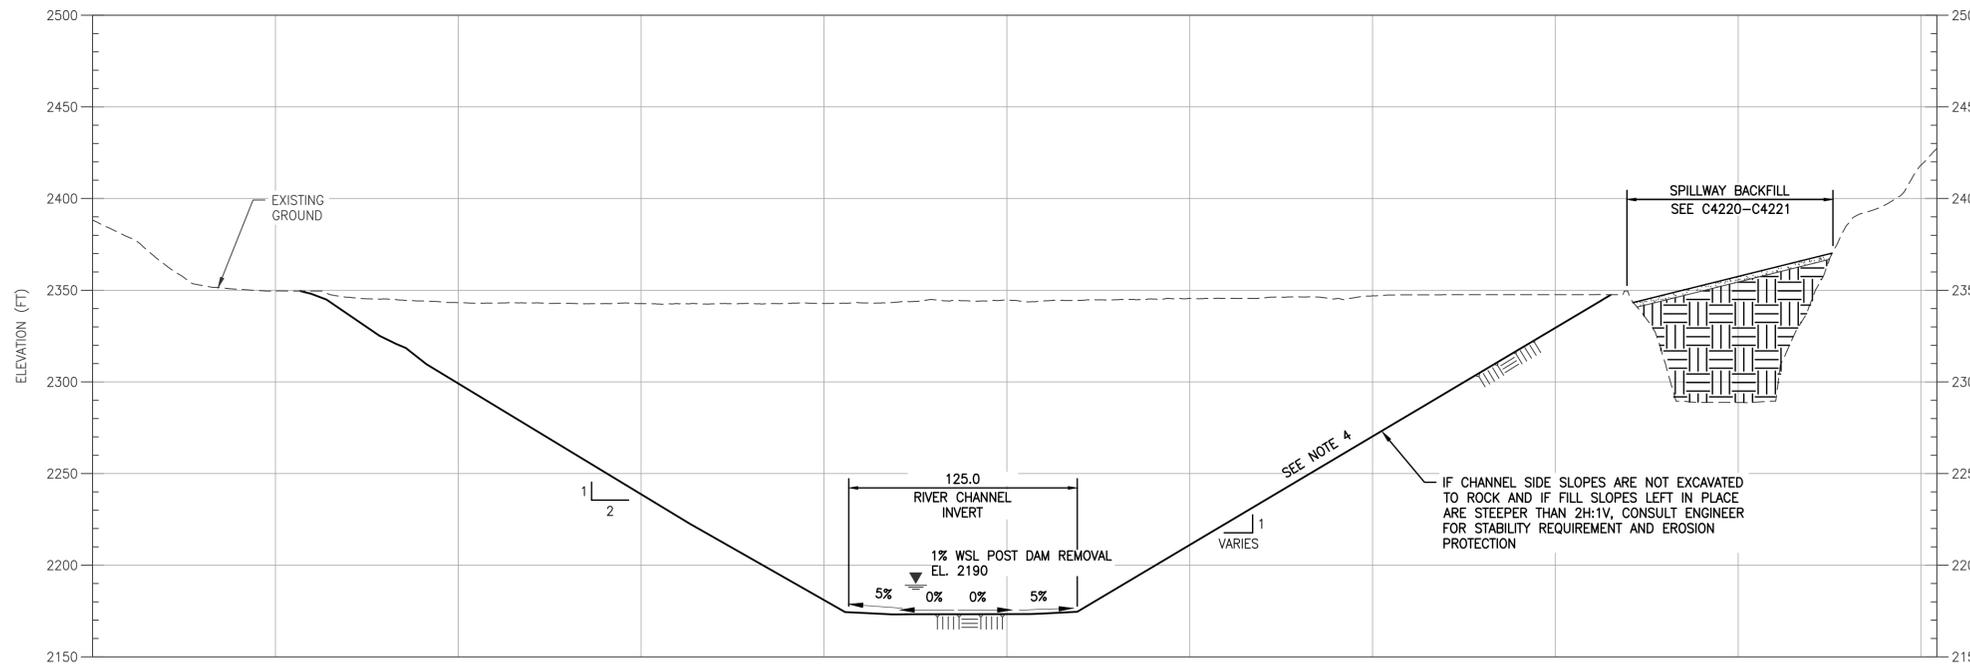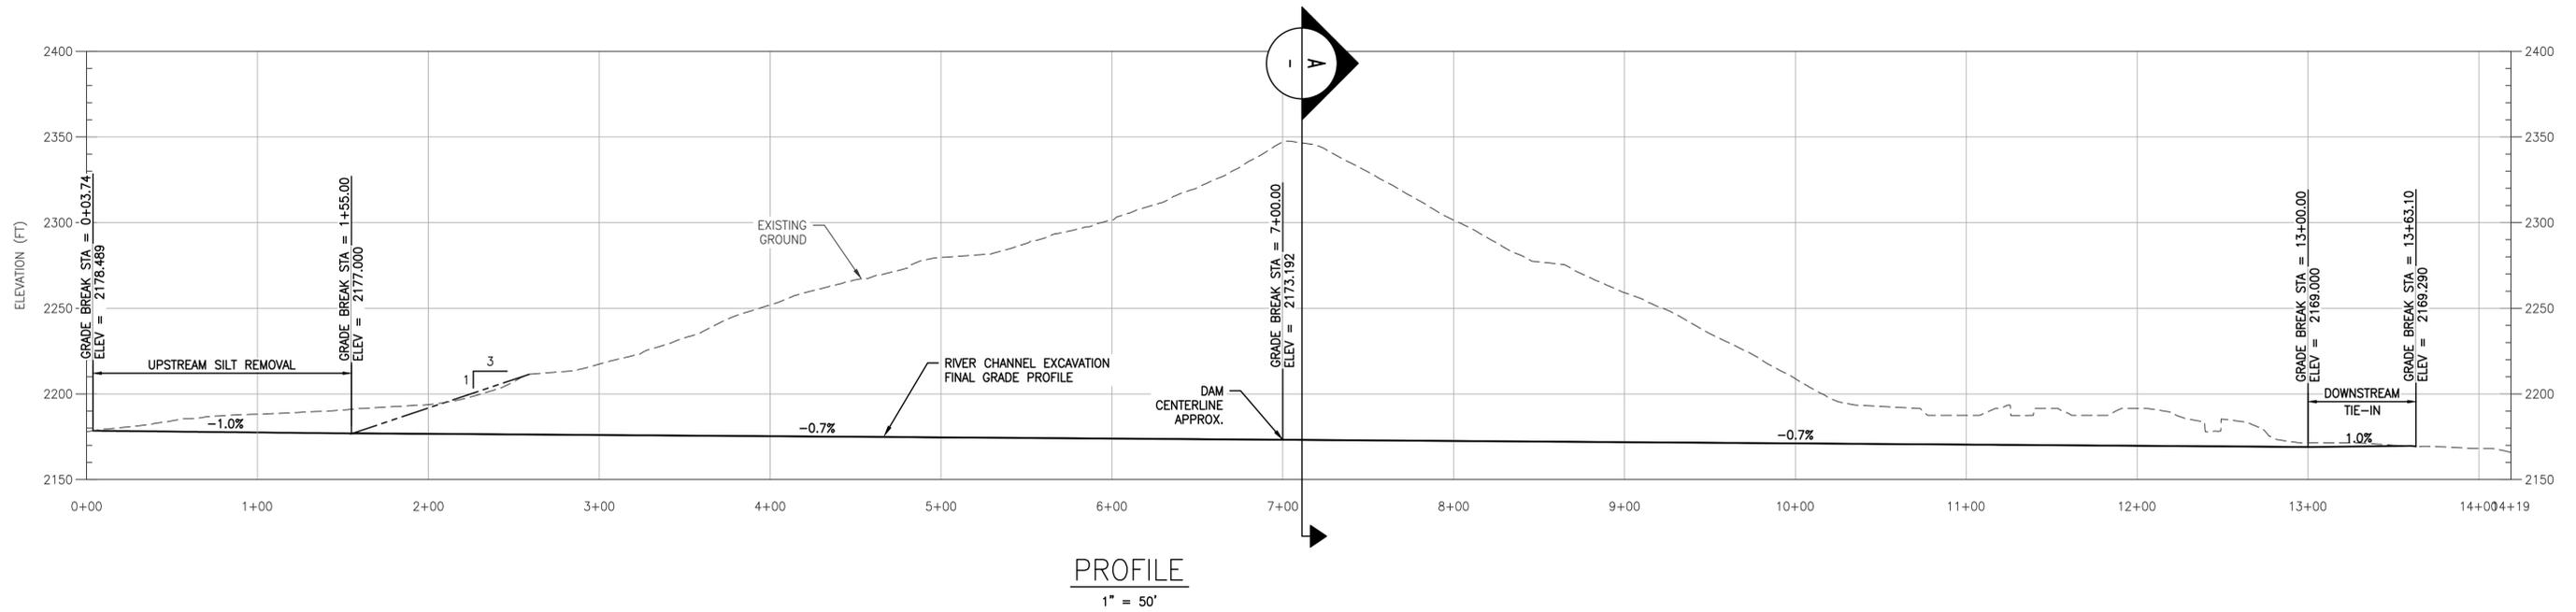

1 DETAIL - TYPICAL DETAIL FOR RIPRAP
C4211 1" = 10'


LEGEND:

- GENERAL FILL (E9)
- RANDOM FILL (E10)
- EROSION PROTECTION (E7b)
- BEDDING (E8)

NOTES:

1. ALL CORE ZONE MATERIAL (ZONE III) SHALL BE EXCAVATED TO BEDROCK. ALL OTHER EXCAVATED SURFACE SHALL BE TO BEDROCK OR EXCAVATION EXTENTS SHOWN HERE.
2. FOR FINAL GRADE SURFACE TREATMENT, SEE DRAWING SERIES C4600.
3. NO EROSION PROTECTION REQUIRED WHERE EXCAVATION IS TO BEDROCK.
4. ALL CUT SLOPES STEEPER THAN 2H:1V SHALL BE EXCAVATED TO BEDROCK. EXACT BEDROCK PROFILE UNKNOWN.
5. ALL CUT SLOPES SHALLOWER THAN 2H:1V SHALL BE EXCAVATED TO BEDROCK OR THE INDICATED CUT SLOPE IN THE DRAWINGS AT THE CONTRACTOR'S OPTION.
6. TOP OF EROSION PROTECTION SHALL PROVIDE A MINIMUM OF 3 ft. OF FREEBOARD ON THE 1% PROBABLE WATER SURFACE LEVEL WHERE RIPRAP DOES NOT GO TO BEDROCK. TOP OF EROSION PROTECTION SHALL APPROXIMATELY FOLLOW THE CHANNEL SLOPE DOWNSTREAM FROM SECTION SHOWN WHERE THE TOP OF EROSION PROTECTION BEGINS AT EL. 2195.5.

ISSUED FOR CONSTRUCTION

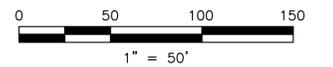


A SECTION - FINAL GRADE SECTION AT DAM CENTERLINE
1" = 50'

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REV	DESCRIPTION	BY	CHK	APP	DATE
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0	ISSUED FOR CONSTRUCTION	KTW	SY	SRM	05/27/22


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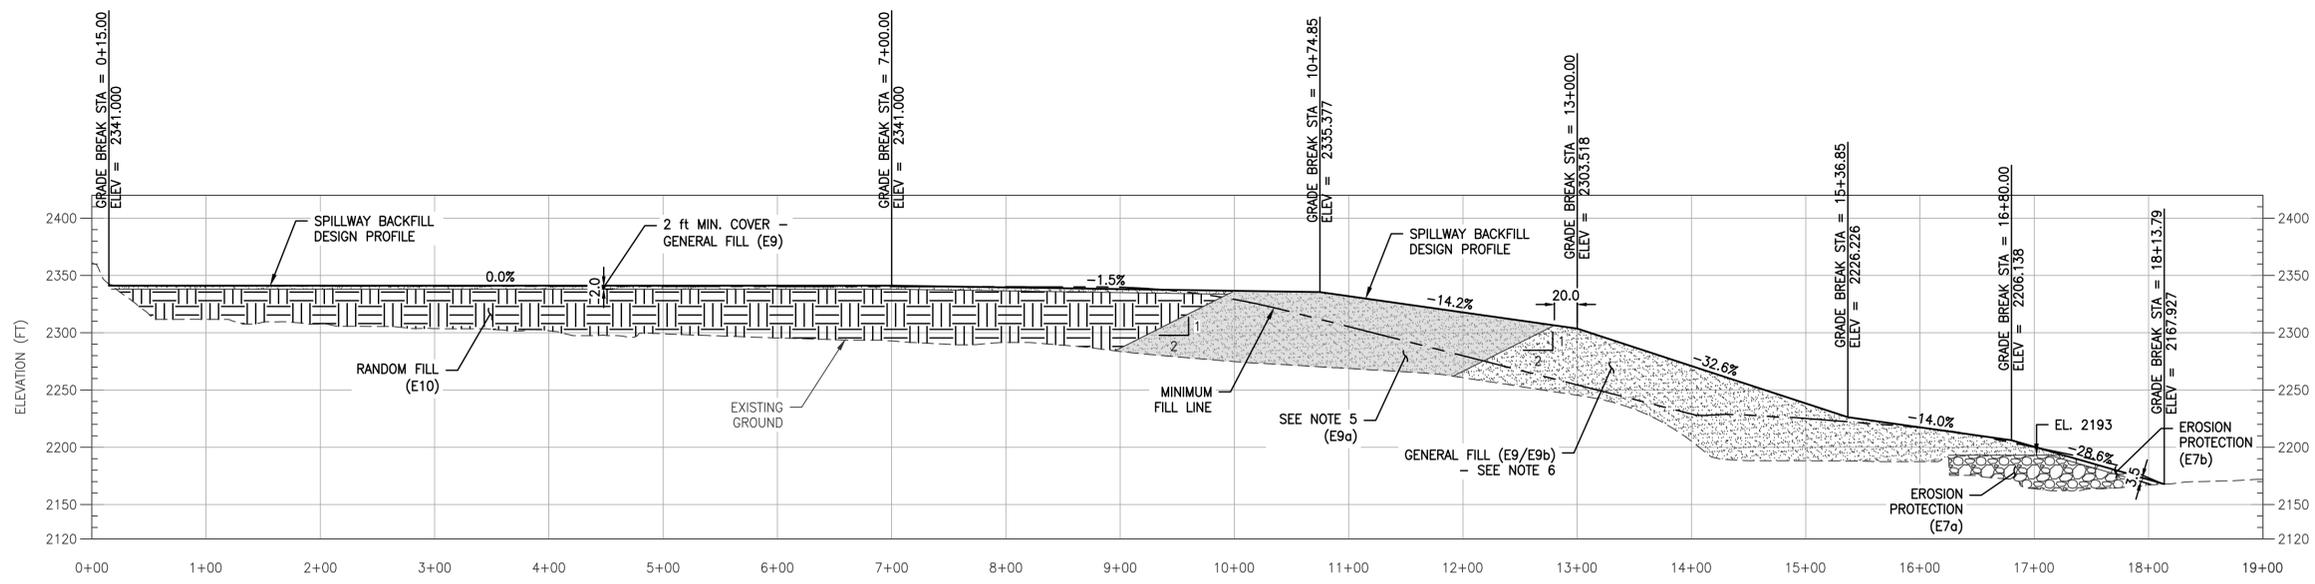
DESIGNED	K. WECHSELBERGER
DRAWN	A. TSENG
REVIEWED	S. YONG
IN CHARGE	N. BISHOP
APPROVED	S. MOTTRAM

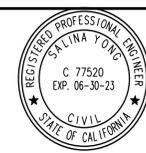

PROJECT	KLAMATH RIVER RENEWAL PROJECT		PROJ#	VA103-640/1
SHEET TITLE	IRON GATE FACILITY EMBANKMENT REMOVAL GRADING CHANNEL PROFILE, SECTION AND DETAIL		DATE	05/27/2022
			DWG	C4212



PLAN
1" = 80'

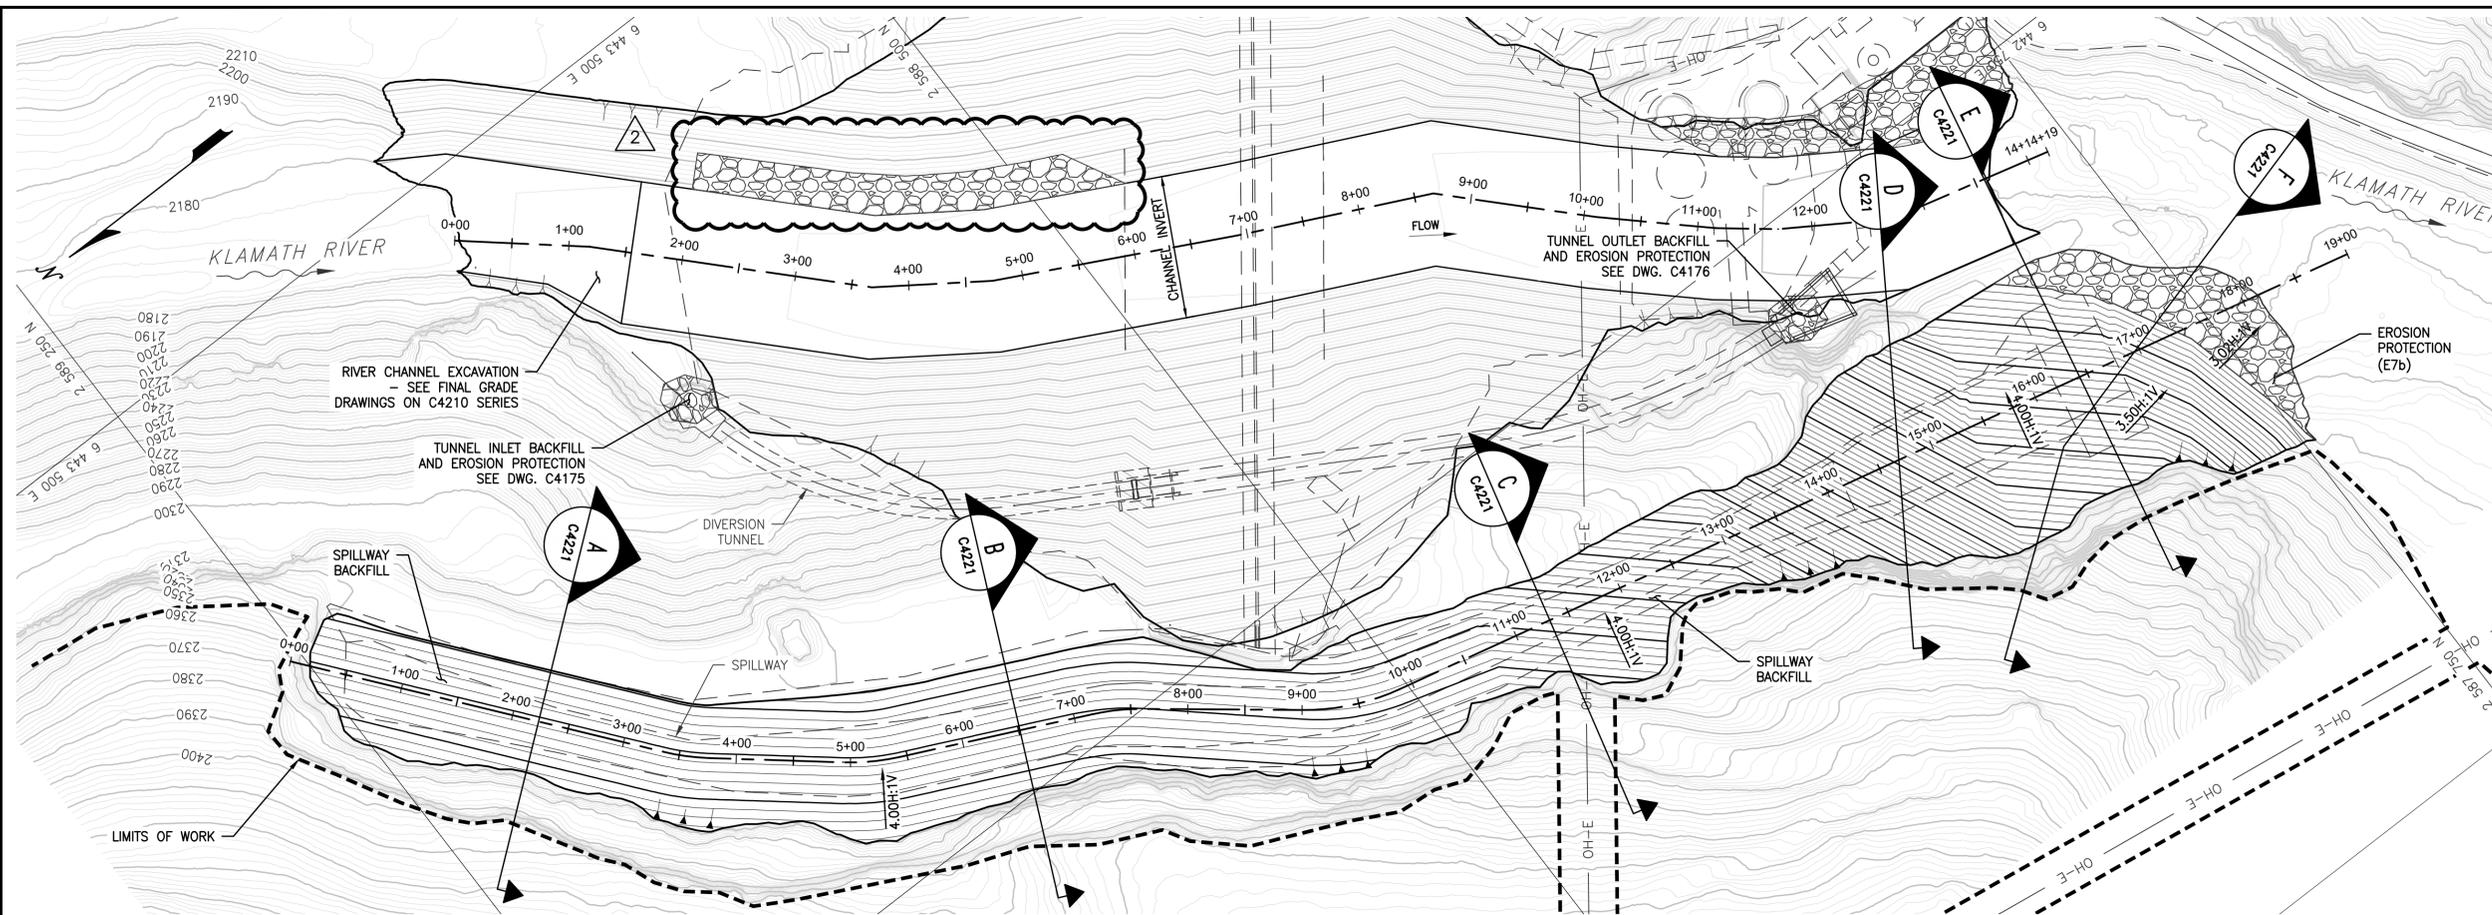


PROFILE
1" = 80'

- NOTES:**
- SPILLWAY INFILL MATERIALS SHALL BE COMPRISED OF REMOVED EMBANKMENT MATERIALS.
 - SPILLWAY INFILL SHALL BE INITIAL EMBANKMENT MATERIAL SPOIL AREA FOR THE UPPER PORTIONS OF THE EMBANKMENT REMOVAL.
 - PLACE EROSION PROTECTION ON DOWNSTREAM TOE OF SPILLWAY FILL ONCE COMPLETE, UPON FINAL GRADING, OR USE RIPRAP REMOVED FROM DOWNSTREAM FACE OF DAM DURING STAGE 1 FOR THE LOWER SPILLWAY LIFTS TO ESTABLISH RIPRAPPED TOE.
 - FOR EROSION AND SEDIMENT CONTROL DETAILS SEE DRAWING SERIES C4215 TO C4219.
 - WHERE E9a IS PLACED IN THE SPILLWAY DISPOSAL SITE, IT SHALL BE PLACED IN ACCORDANCE WITH THE LIFT THICKNESS AND COMPACTION REQUIREMENTS OF E9.
 - OPTION TO UTILIZE GENERAL FILL (E9) OR (E9b) AS COVER MATERIAL. FINAL STABILIZATION TREATMENTS DIFFER AS PER TECHNICAL SPECIFICATION 31 25 00.

- LEGEND:**
- GENERAL FILL (E9/E9a/E9b)
 - RANDOM FILL (E10)
 - EROSION PROTECTION (E7a/E7b)

ISSUED FOR CONSTRUCTION

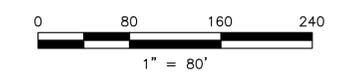

REV	DESCRIPTION	BY	CHK	APP	DATE
2	EROSION PROTECTION LIMITS CORRECTED	KTW	SY	SRM	12/21/22
1	ISSUED FOR CONSTRUCTION	KTW	SY	SRM	06/22/22
0	ISSUED FOR CONSTRUCTION	KTW	SY	SRM	05/27/22







WARNING
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IF THIS BAR DOES NOT MEASURE 1" THEN DRAWING IS NOT TO SCALE

PREPARED BY
 Knight Piésold CONSULTING
 Kiewit

DESIGNED: K. WECHSELBERGER
 DRAWN: A. TSENG
 REVIEWED: S. YONG
 IN CHARGE: N. BISHOP
 APPROVED: S. MOTTRAM

PREPARED FOR
 KLAMATH RIVER RENEWAL CORPORATION

PROJECT	KLAMATH RIVER RENEWAL PROJECT		PROJ#	VA103-640/1
DATE	05/27/2022		DATE	05/27/2022
SHEET TITLE	IRON GATE FACILITY EMBANKMENT AND SPILLWAY SPILLWAY INFILL - FINAL GRADE AND PROFILE		DWG	C4220

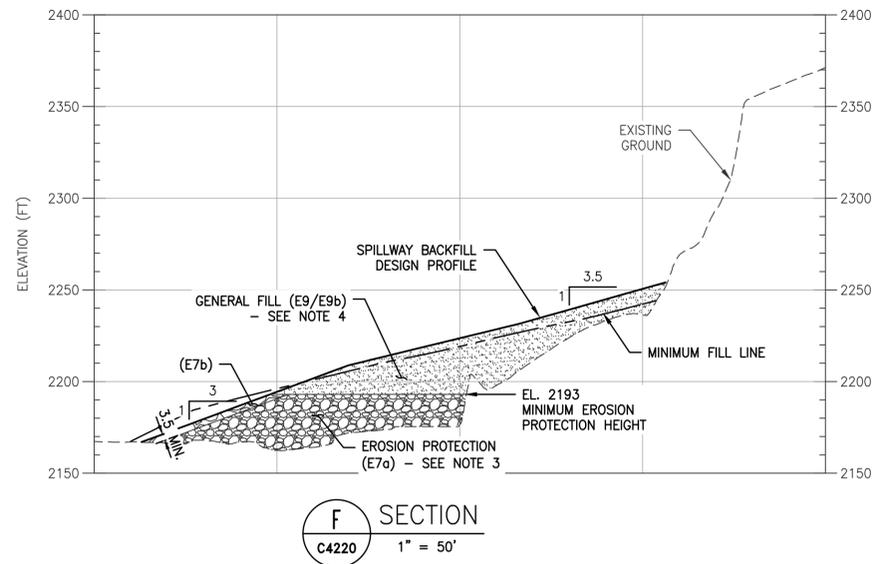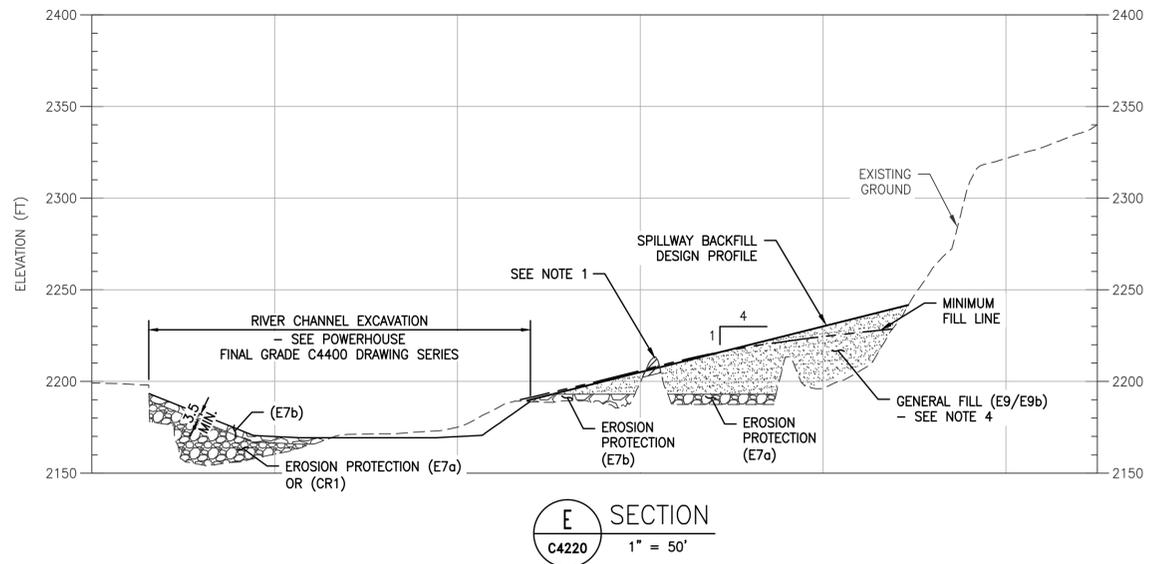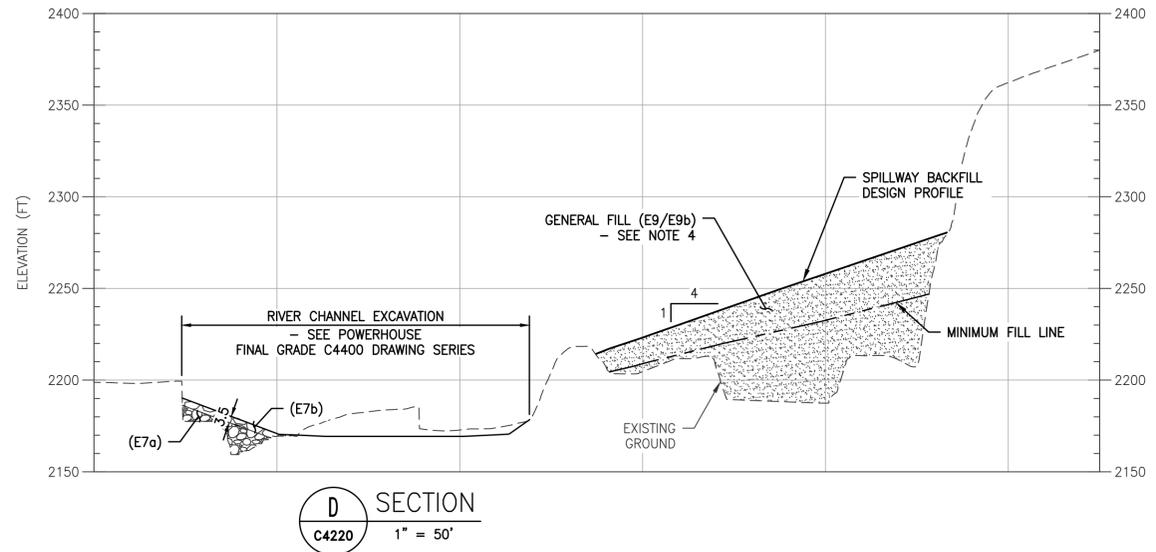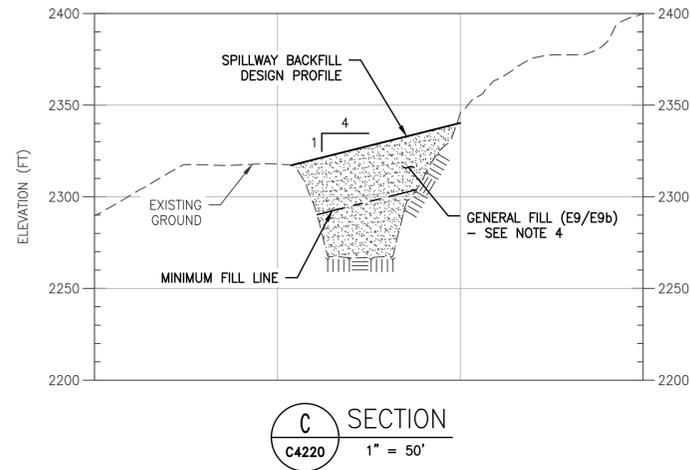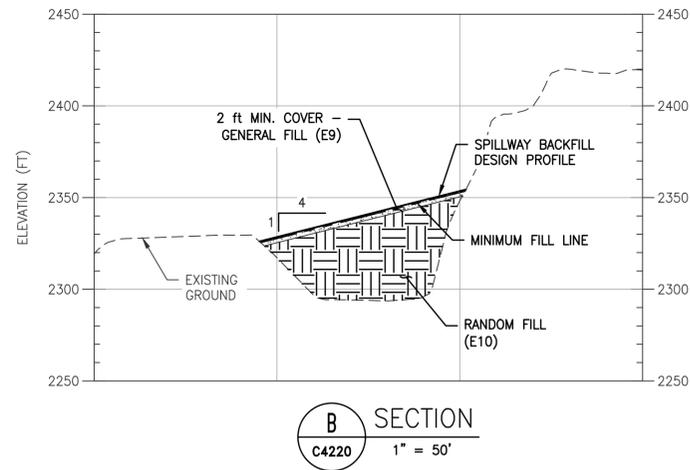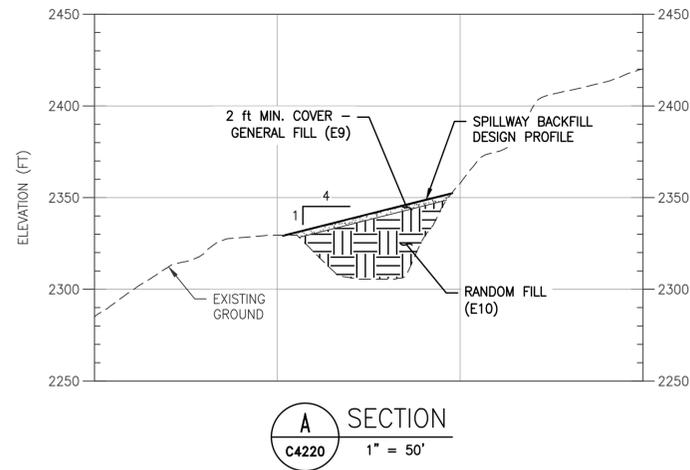


NOTES:

1. REMOVE PORTION OF CONCRETE SPILLWAY CHUTE AS NEEDED TO BE AT MINIMUM 2 ft BELOW PROPOSED GRADE.
2. SALVAGED EROSION PROTECTION FROM THE DOWNSTREAM FACE OF THE DAM.
3. WHERE ABOVE THE WATER LINE AT THE TIME OF PLACEMENT, E7a CAN BE REPLACED WITH E9, GENERAL FILL, AND PROTECTED WITH E8, BEDDING AND E7b, EROSION PROTECTION, CONSISTING WITH THE TYPICAL DETAIL SHOWN ON C4212.
4. OPTION TO UTILIZE GENERAL FILL (E9) OR (E9b) AS COVER MATERIAL. FINAL STABILIZATION TREATMENTS DIFFER AS PER TECHNICAL SPECIFICATION 31 25 00.

LEGEND:

- GENERAL FILL (E9/E9b)
- RANDOM FILL (E10)
- EROSION PROTECTION (E7b)
- DEMOLITION / REMOVAL


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0	ISSUED FOR CONSTRUCTION	KTW	SY	SRM	05/27/22

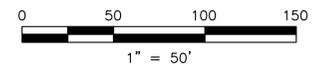
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DRAWN	A. TSENG
REVIEWED	S. YONG
IN CHARGE	N. BISHOP
APPROVED	S. MOTTRAM




PROJECT	KLAMATH RIVER RENEWAL PROJECT			
PROJ#	VA103-640/1	DATE	05/27/2022	
SHEET TITLE	IRON GATE FACILITY EMBANKMENT AND SPILLWAY SPILLWAY INFILL - FINAL GRADE SECTIONS		DWG	C4221

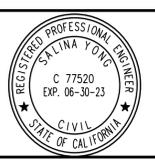

POWERHOUSE SITE PLAN - SEQUENCE 1

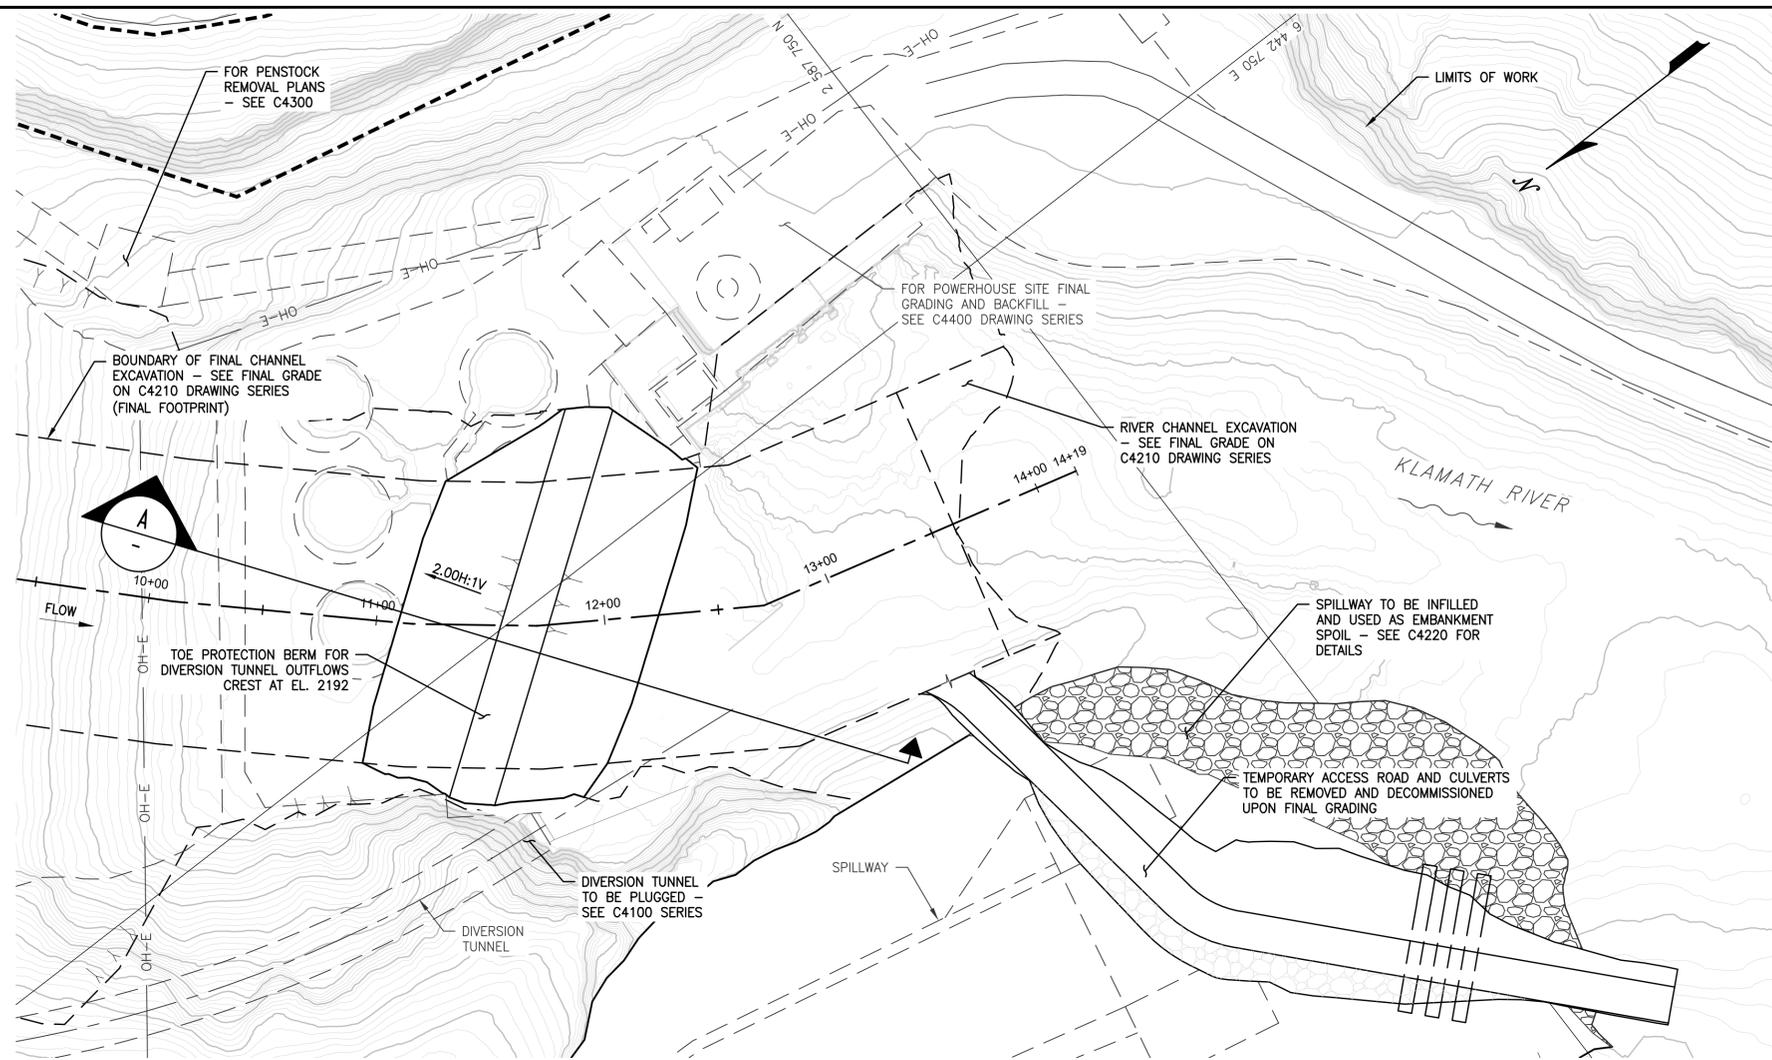1" = 40'

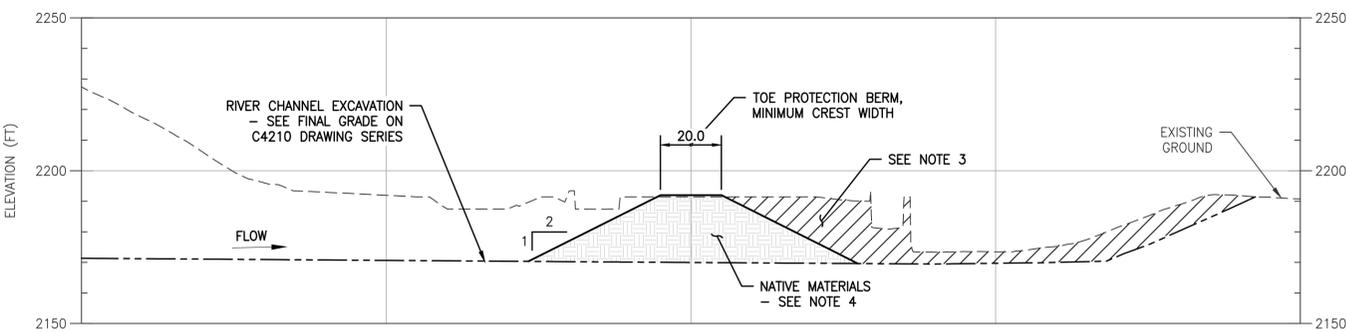

SECTION A
1" = 30'


NOTES:

1. REMOVE REMAINING THREE FISH HOLDING FACILITIES.
2. POWERHOUSE TO BE DEMOLISHED AND BACKFILLED SEE DRAWINGS C4401 TO C4403 FOR FINAL GRADE AND DEMO LIMITS.
3. REMOVE ANY REMAINING FISH LADDER CONCRETE NOT REMOVED PRIOR TO DRAWDOWN.
4. TOE PROTECTION BERM TO BE COMPRISED OF NATIVE MATERIALS, ONCE EXCAVATION IS COMPLETE MATERIAL SHALL BE ASSESSED FOR WATER RETAINING PROPERTIES. CORE ZONE MATERIAL TO BE SALVAGED AND USED AS NECESSARY TO PROTECT EMBANKMENT EXCAVATION FROM BACKWATERING TAILRACE FLOWS.

LEGEND:

- (E) EARTHFILL
- EROSION PROTECTION (E7b)
- DEMOLITION / REMOVAL

ISSUED FOR CONSTRUCTION

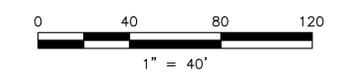

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REV	DESCRIPTION	BY	CHK	APP	DATE
0	ISSUED FOR CONSTRUCTION	KTW	SY	SRM	05/27/22

WARNING
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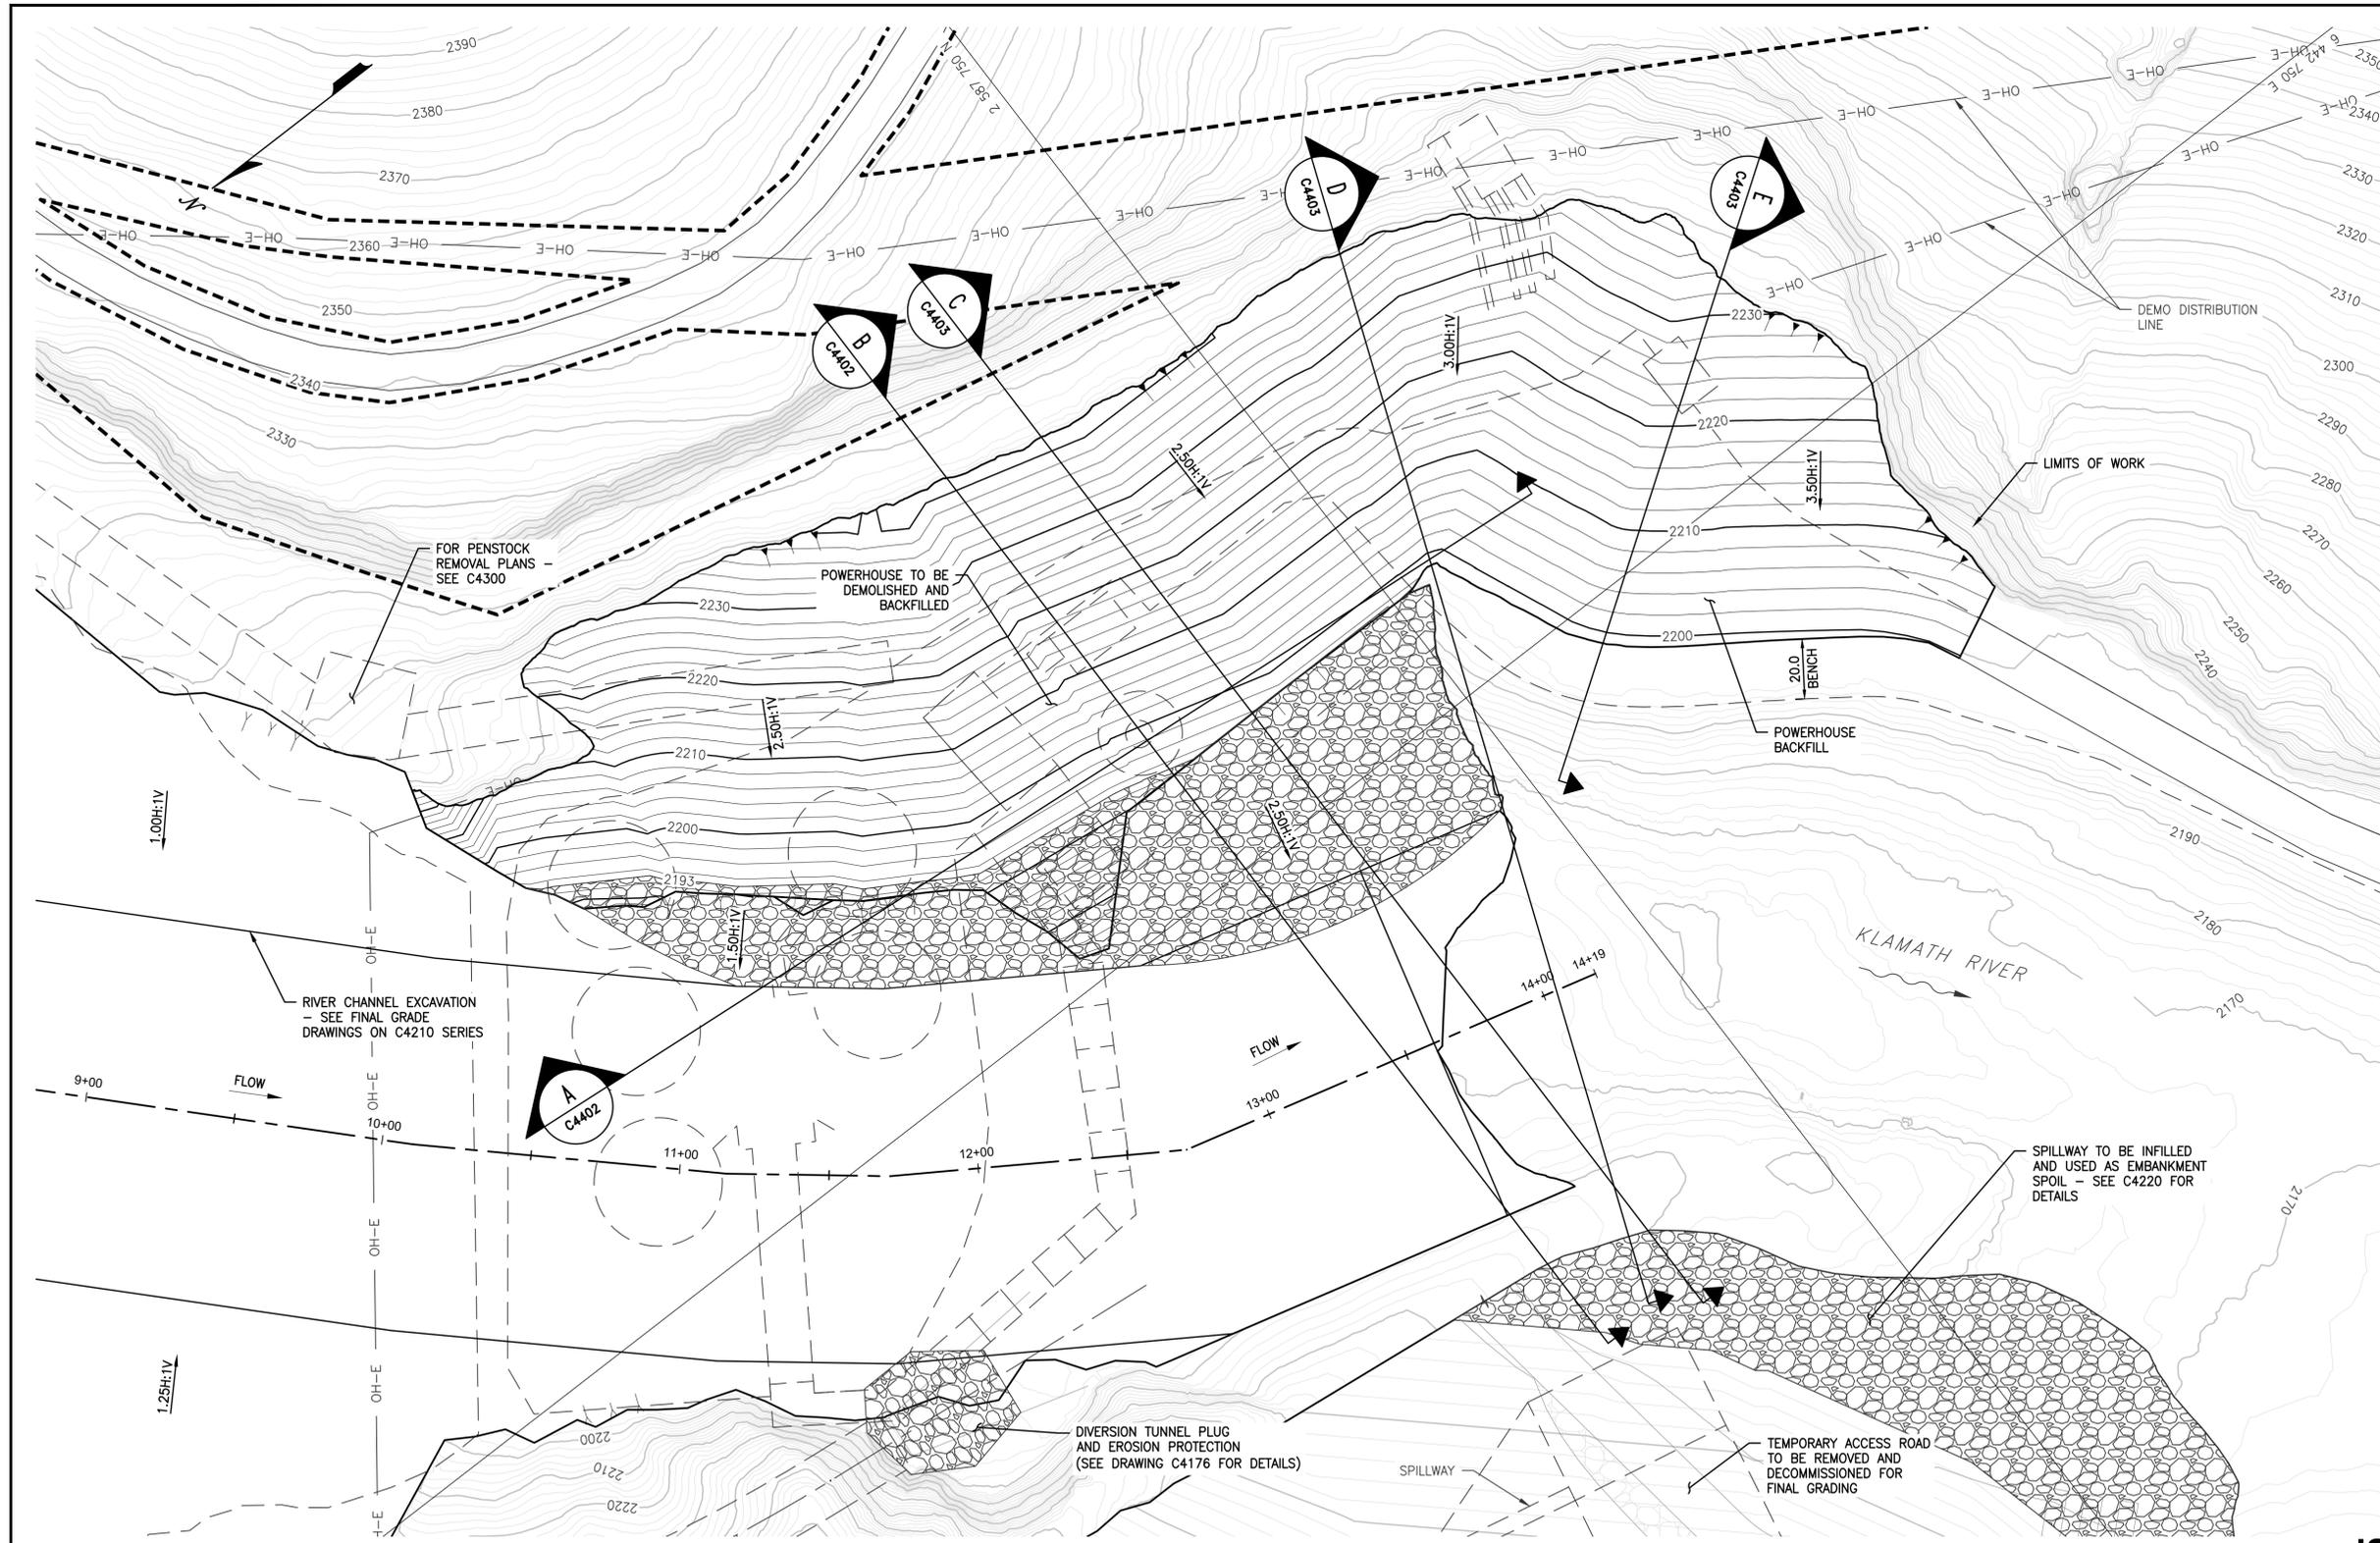


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APPROVED	S. MOTTRAM

PREPARED FOR
 KLAMATH RIVER RENEWAL CORPORATION

PROJECT	KLAMATH RIVER RENEWAL PROJECT		PROJ#	VA103-640/1
SHEET TITLE	IRON GATE FACILITY POWERHOUSE AND FISH FACILITIES REMOVAL AND GRADING - (SHEET 1 OF 2)		DATE	05/27/2022
			DWG	C4400



NOTES:


1. REMOVE ALL MECHANICAL AND ELECTRICAL EQUIPMENT PRIOR TO BACKFILL OF POWERHOUSE AND TAILRACE, WITH THE EXCEPTION OF EMBEDDED STEEL WHICH MAY BE BURIED IN PLACE.
2. ALL OIL AND WATER SUPPLY LINES TO BE FLUSHED PRIOR TO BACKFILL.
3. POWERHOUSE SITE INFILL AND SPOIL SHALL BE COMPRISED OF REMOVED EMBANKMENT MATERIALS (E9) OR CONCRETE RUBBLE (CR1).
4. ALL FILL SHALL BE CAPPED WITH A MINIMUM OF 3 ft OF COVER MATERIAL CONSISTENT WITH C4600 DRAWING SERIES.
5. EROSION PROTECTION SHALL PROVIDE A MINIMUM OF 3 ft OF FREEBOARD OVER THE 1% PROBABLE WATER SURFACE LEVEL BEGINNING AT A MINIMUM ELEVATION OF 2193 ft. AND SHALL APPROXIMATELY FOLLOW THE CHANNEL SLOPE DOWNSTREAM.

LEGEND:

EROSION PROTECTION (E7b)

POWERHOUSE SITE PLAN – FINAL GRADE
1" = 30'

ISSUED FOR CONSTRUCTION

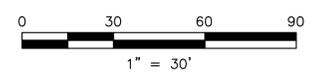

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REV	DESCRIPTION	BY	CHK	APP	DATE
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0	ISSUED FOR CONSTRUCTION	KTW	SY	SRM	05/27/22


WARNING
0 1/2 1
IF THIS BAR DOES NOT MEASURE 1" THEN DRAWING IS NOT TO SCALE



DESIGNED	K. WECHSELBERGER
DRAWN	A. TSENG
REVIEWED	S. YONG
IN CHARGE	N. BISHOP
APPROVED	S. MOTTRAM



PROJECT	KLAMATH RIVER RENEWAL PROJECT	PROJ#	VA103-640/1
SHEET TITLE	IRON GATE FACILITY POWERHOUSE AND FISH FACILITIES REMOVAL AND GRADING - (SHEET 2 OF 2)	DATE	05/27/2022
		DWG	C4401

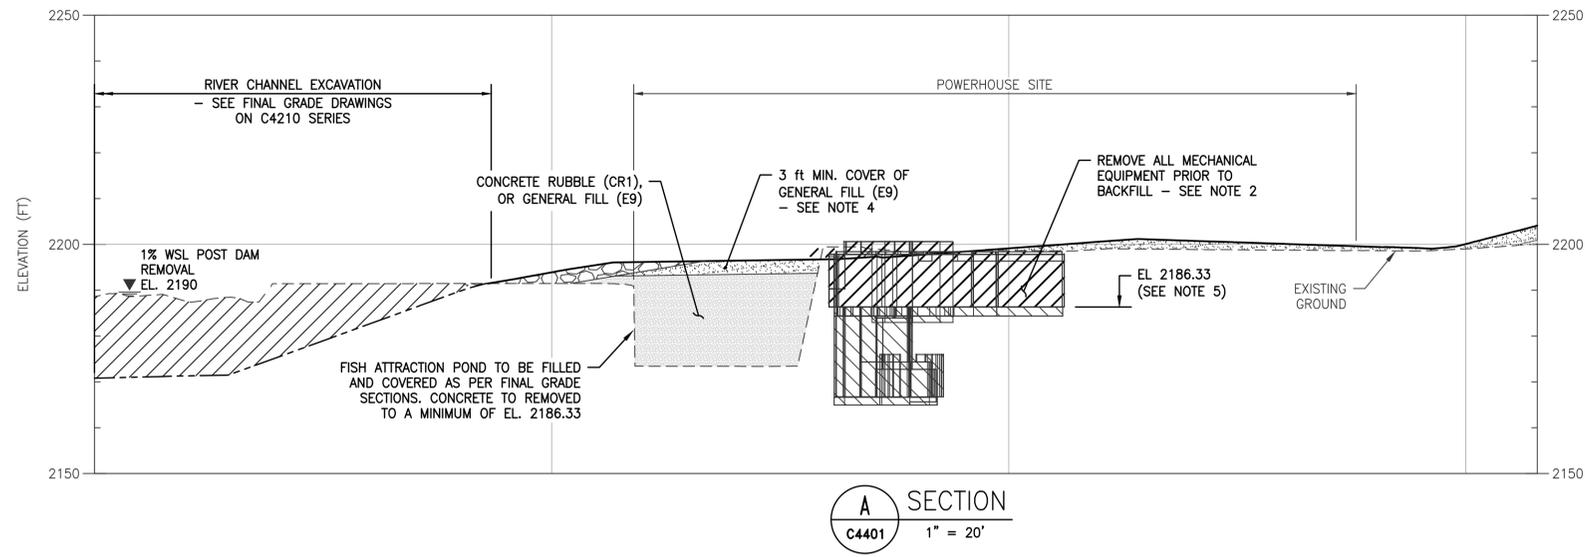


NOTES:


1. REMOVE ALL MECHANICAL AND ELECTRICAL EQUIPMENT PRIOR TO BACKFILL OF POWERHOUSE AND TAILRACE.
2. ALL OIL AND WATER SUPPLY LINES TO BE FLUSHED PRIOR TO BACKFILL.
3. POWERHOUSE SITE INFILL AND SPOIL SHALL BE COMPRISED OF REMOVED EMBANKMENT MATERIALS (E9) OR CONCRETE RUBBLE (CR1).
4. WHERE CONCRETE RUBBLE IS SPOILED, IT MUST BE CAPPED BY A MINIMUM LAYER OF 3 ft OF COVER MATERIAL.
5. RECOMMENDED MINIMUM CONCRETE REMOVAL IS 2186.33 ft.
6. POWERHOUSE FILL AND SPILLWAY FILL TOES SHALL BE CONSTRUCTED OF STOCKPILED RIPRAP FROM THE DOWNSTREAM FACE OF THE DAM UP TO ELEVATION 2193 ft OR PROTECTED WITH EROSION PROTECTION, FILL TYPE E7b AND BEDDING TYPE E8.
7. SEE TECHNICAL SPECIFICATION 31 23 00 FOR PLACEMENT AND COMPACTION REQUIREMENTS IN CONFINED OPENINGS AND CAVITIES.

LEGEND:

-  DEMOLITION / REMOVAL
-  GENERAL FILL (E9)
-  CONCRETE RUBBLE (CR1/CR2)
-  EROSION PROTECTION (E7a/E7b)
-  VOID INFILL

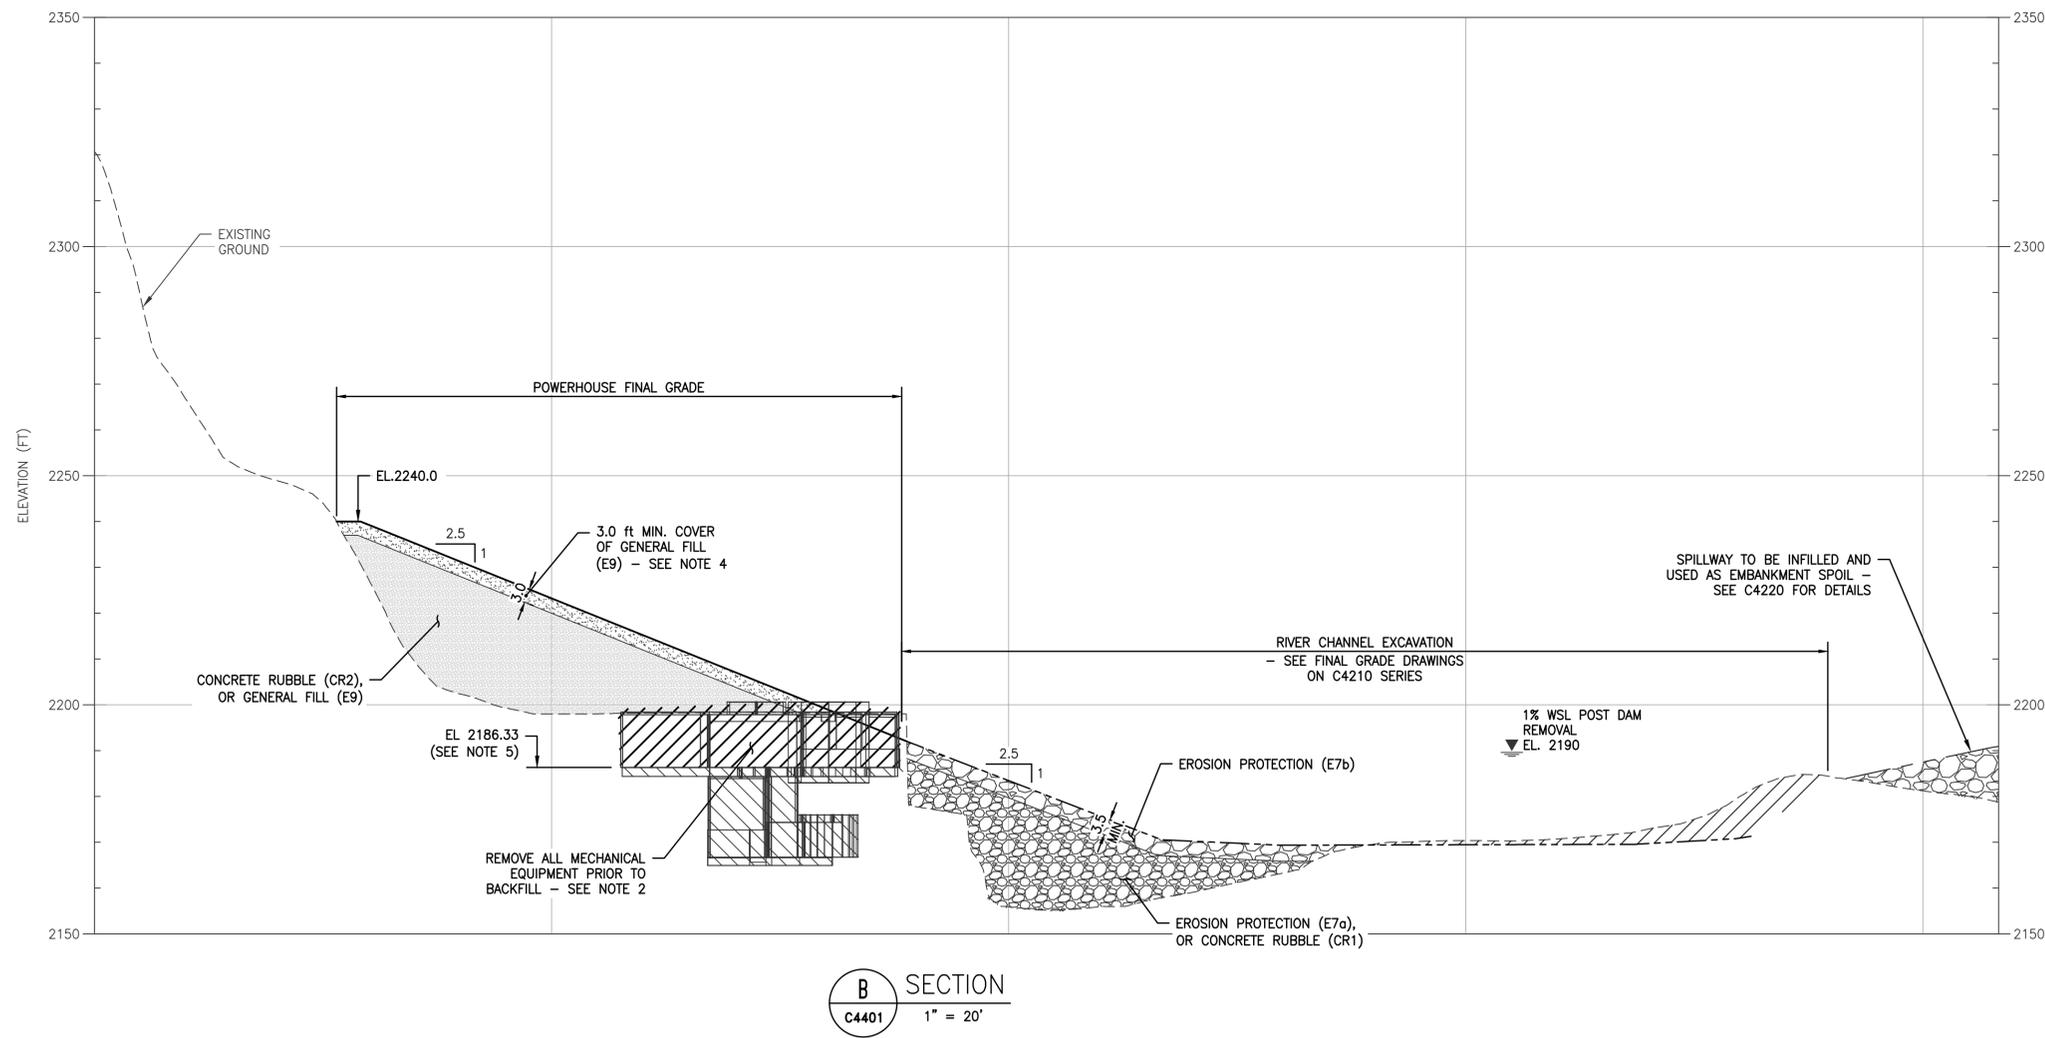

ISSUED FOR CONSTRUCTION

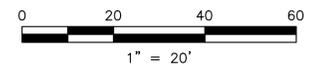

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REV	DESCRIPTION	BY	CHK	APP	DATE
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0	ISSUED FOR CONSTRUCTION	KTW	SY	SRM	05/27/22


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DESIGNED	K. WECHSELBERGER
DRAWN	A. TSENG
REVIEWED	S. YONG
IN CHARGE	N. BISHOP
APPROVED	S. MOTTRAM




PROJECT	KLAMATH RIVER RENEWAL PROJECT	
PROJ#	VA103-640/1	
DATE	05/27/2022	
SHEET TITLE	IRON GATE FACILITY POWERHOUSE AND FISH FACILITIES FINAL GRADE SECTIONS - (SHEET 1 OF 2)	
DWG	C4402	




C SECTION
C4401 1" = 20'

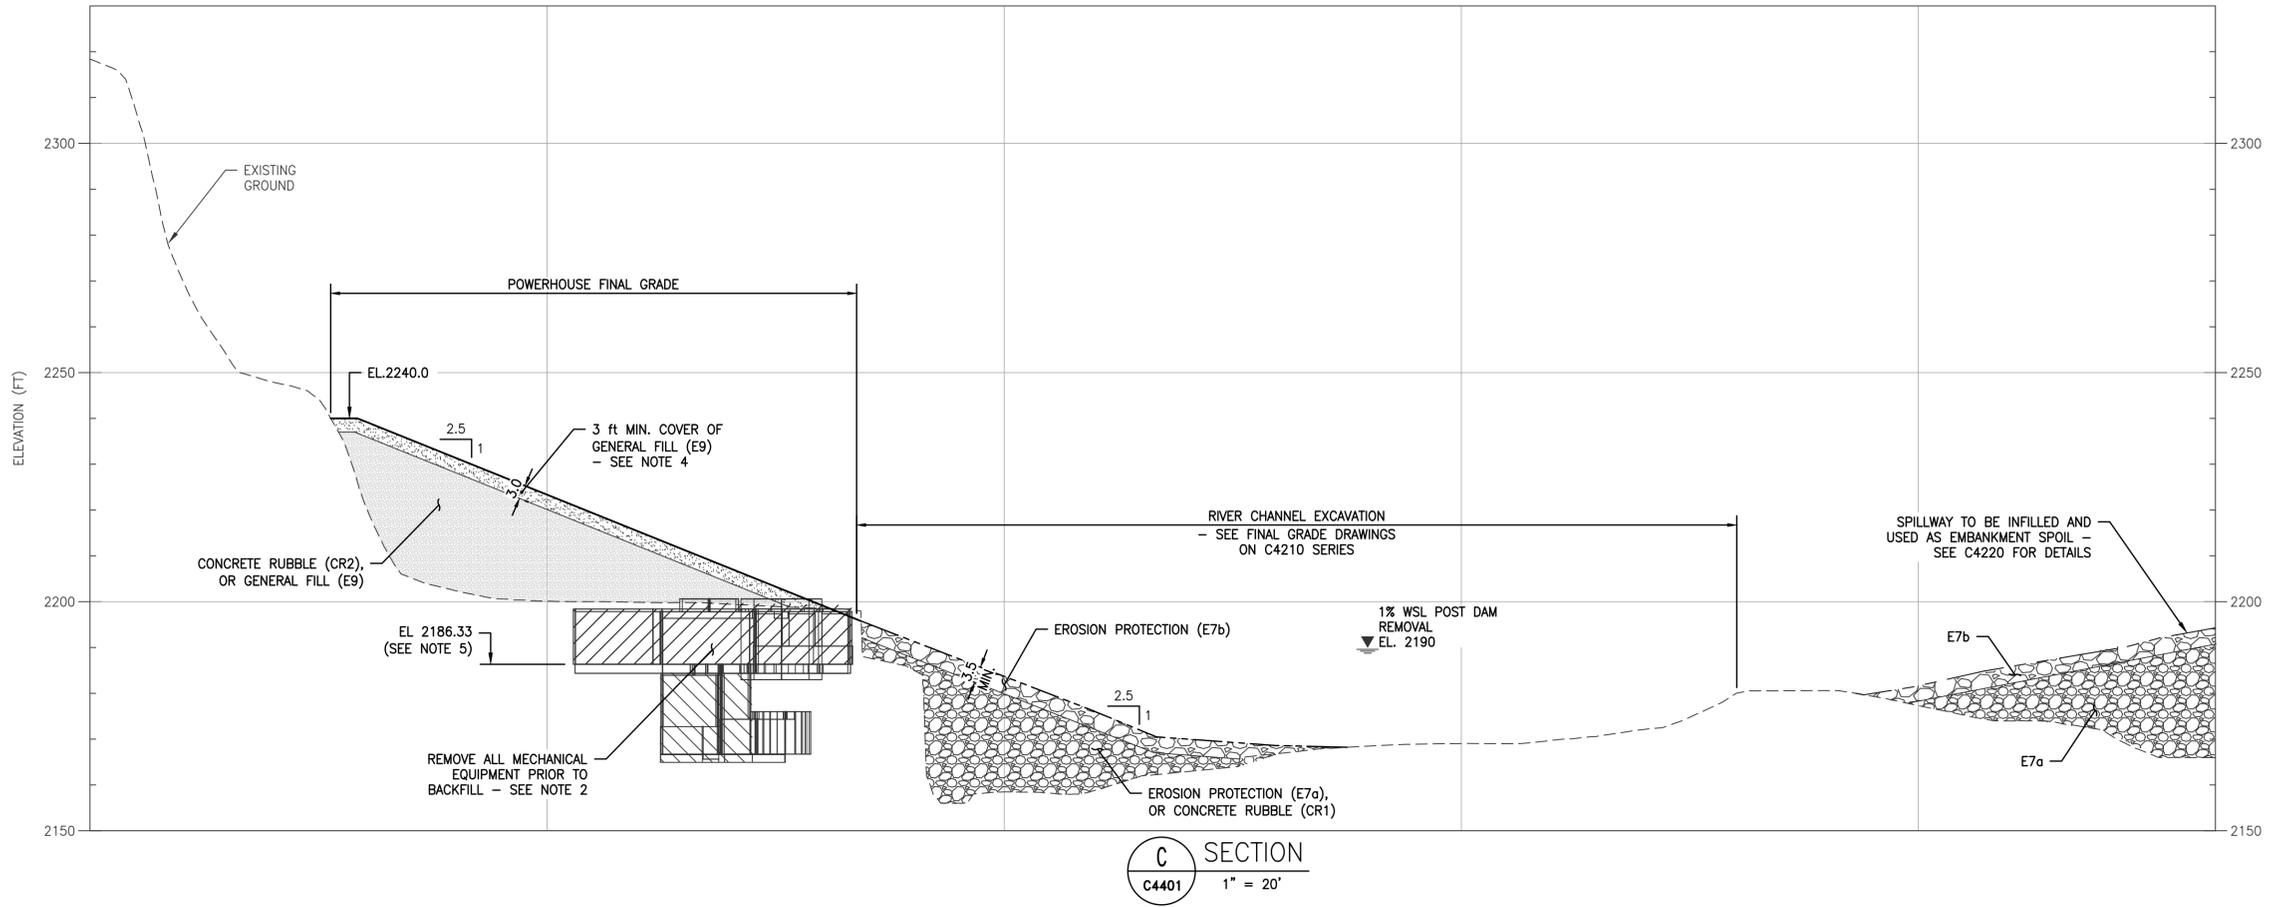- NOTES:**
1. REMOVE ALL MECHANICAL AND ELECTRICAL EQUIPMENT PRIOR TO BACKFILL OF POWERHOUSE AND TAILRACE.
 2. ALL OIL AND WATER SUPPLY LINES TO BE FLUSHED PRIOR TO BACKFILL.
 3. POWERHOUSE SITE INFILL AND SPOIL SHALL BE COMPRISED OF REMOVED EMBANKMENT MATERIALS (E9) OR CONCRETE RUBBLE (CR1).
 4. WHERE CONCRETE RUBBLE IS SPOILED, IT MUST BE CAPPED BY A MINIMUM LAYER OF 3 ft OF COVER MATERIAL.
 5. RECOMMENDED MINIMUM CONCRETE REMOVAL IS 2186.33 ft.
 6. POWERHOUSE FILL AND SPILLWAY FILL TOES SHALL BE CONSTRUCTED OF STOCKPILED RIPRAP FROM THE DOWNSTREAM FACE OF THE DAM UP TO ELEVATION 2193 ft OR PROTECTED WITH EROSION PROTECTION, FILL TYPE E7b AND BEDDING TYPE E8.
 7. SEE TECHNICAL SPECIFICATION 31 23 00 FOR PLACEMENT AND COMPACTION REQUIREMENTS IN CONFINED OPENINGS AND CAVITIES.

- LEGEND:**
- DEMOLITION / REMOVAL
 - GENERAL FILL (E9)
 - CONCRETE RUBBLE (CR1/CR2)
 - EROSION PROTECTION (E7a/E7b)
 - VOID INFILL

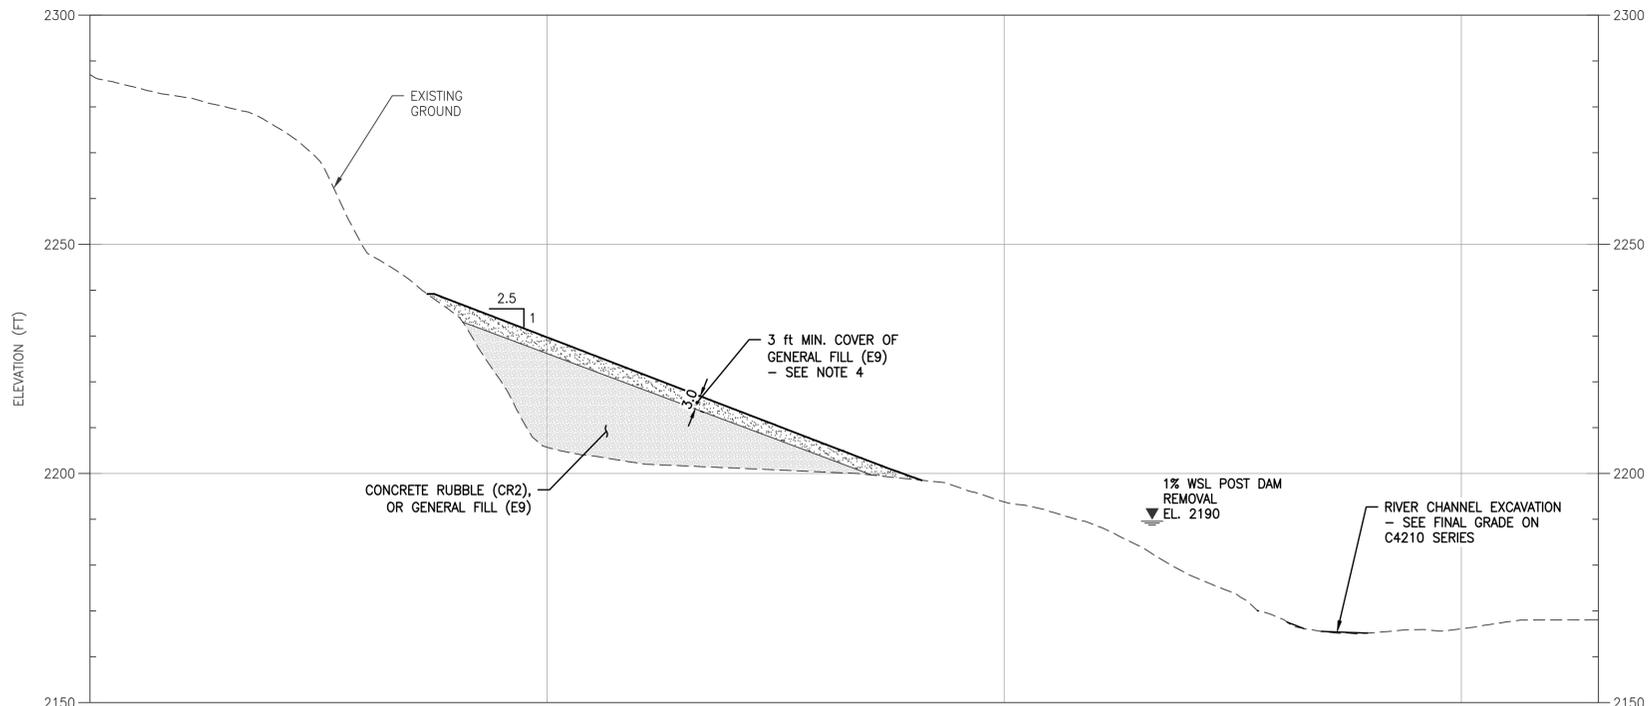


D SECTION
C4401 1" = 20'

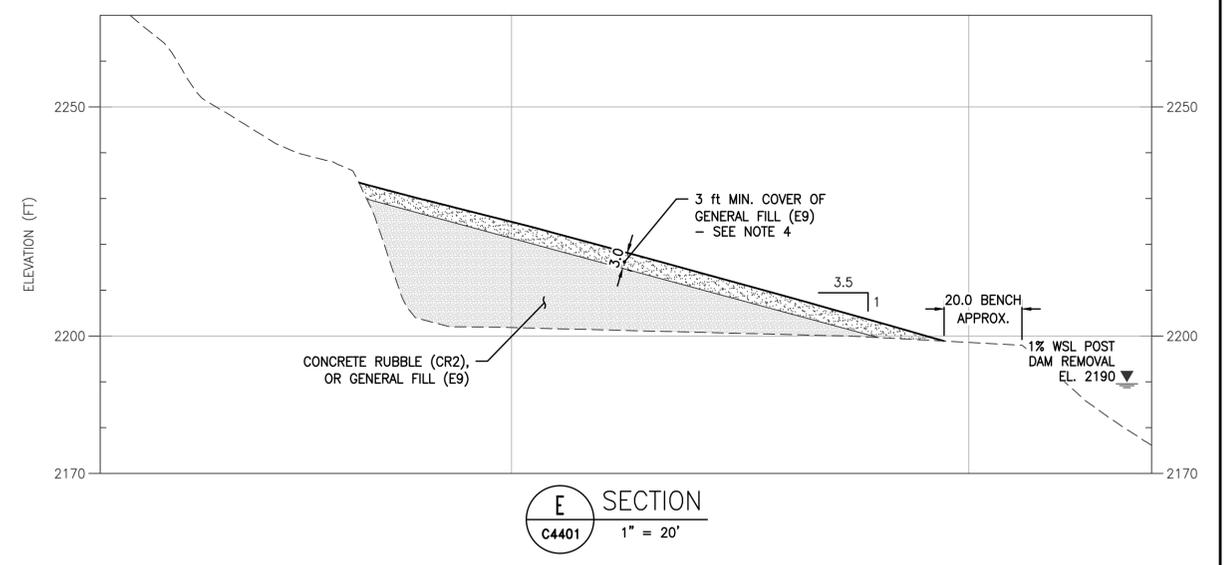

E SECTION
C4401 1" = 20'

ISSUED FOR CONSTRUCTION

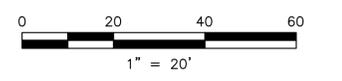

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REV	DESCRIPTION	BY	CHK	APP	DATE
1	ISSUED FOR CONSTRUCTION	KTW	SY	SRM	06/22/22
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DESIGNED	K. WECHSELBERGER
DRAWN	A. TSENG
REVIEWED	S. YONG
IN CHARGE	N. BISHOP
APPROVED	S. MOTTRAM



PROJECT	KLAMATH RIVER RENEWAL PROJECT
SHEET TITLE	IRON GATE FACILITY POWERHOUSE AND FISH FACILITIES FINAL GRADE SECTIONS - (SHEET 2 OF 2)

PROJ#	VA103-640/1
DATE	05/27/2022
DWG	C4403

